




AREA ANALYSIS

SITE AREA	m²	%
PROPOSED SITE COVERAGE	1930.43	75.50
PROPOSED SITE PERMEABILITY	571.60	22.40

FLOOR AREA	m²	sq's
BASEMENT LEVEL 1	2113.00	227.45
BASEMENT LEVEL 2	2113.00	227.45
GROUND FLOOR - MEDICAL CENTRE, CAFE, COMMUNAL AREAS	1682.48	181.11
GROUND FLOOR - CHILDCARE CENTRE	254.33	27.37
GROUND FLOOR - OUTDOOR PLAY AREA	101.98	10.97
FIRST FLOOR - CHILDCARE CENTRE	858.16	92.37
FIRST FLOOR - OUTDOOR PLAY AREA	912.32	98.20
SECOND FLOOR	1248.23	134.36
THIRD FLOOR	1146.50	123.41
ROOF	1070.70	115.25
TOTAL AREA	11,500.70	1237.94

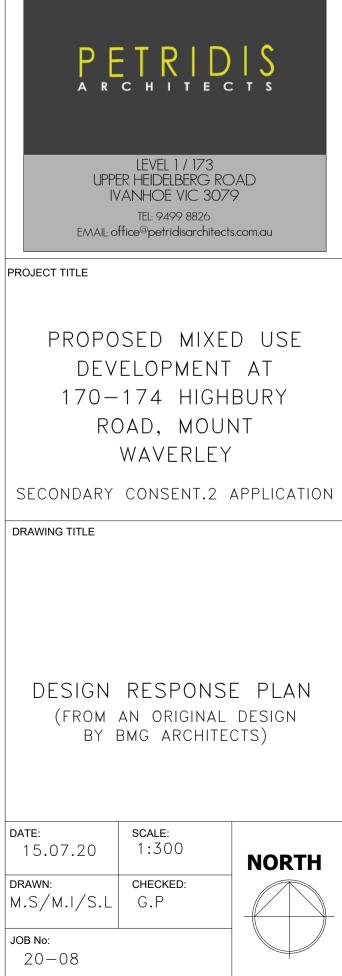


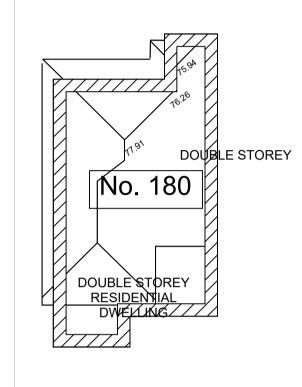


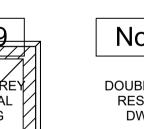

DWG No: DR01 REVISION

Ν

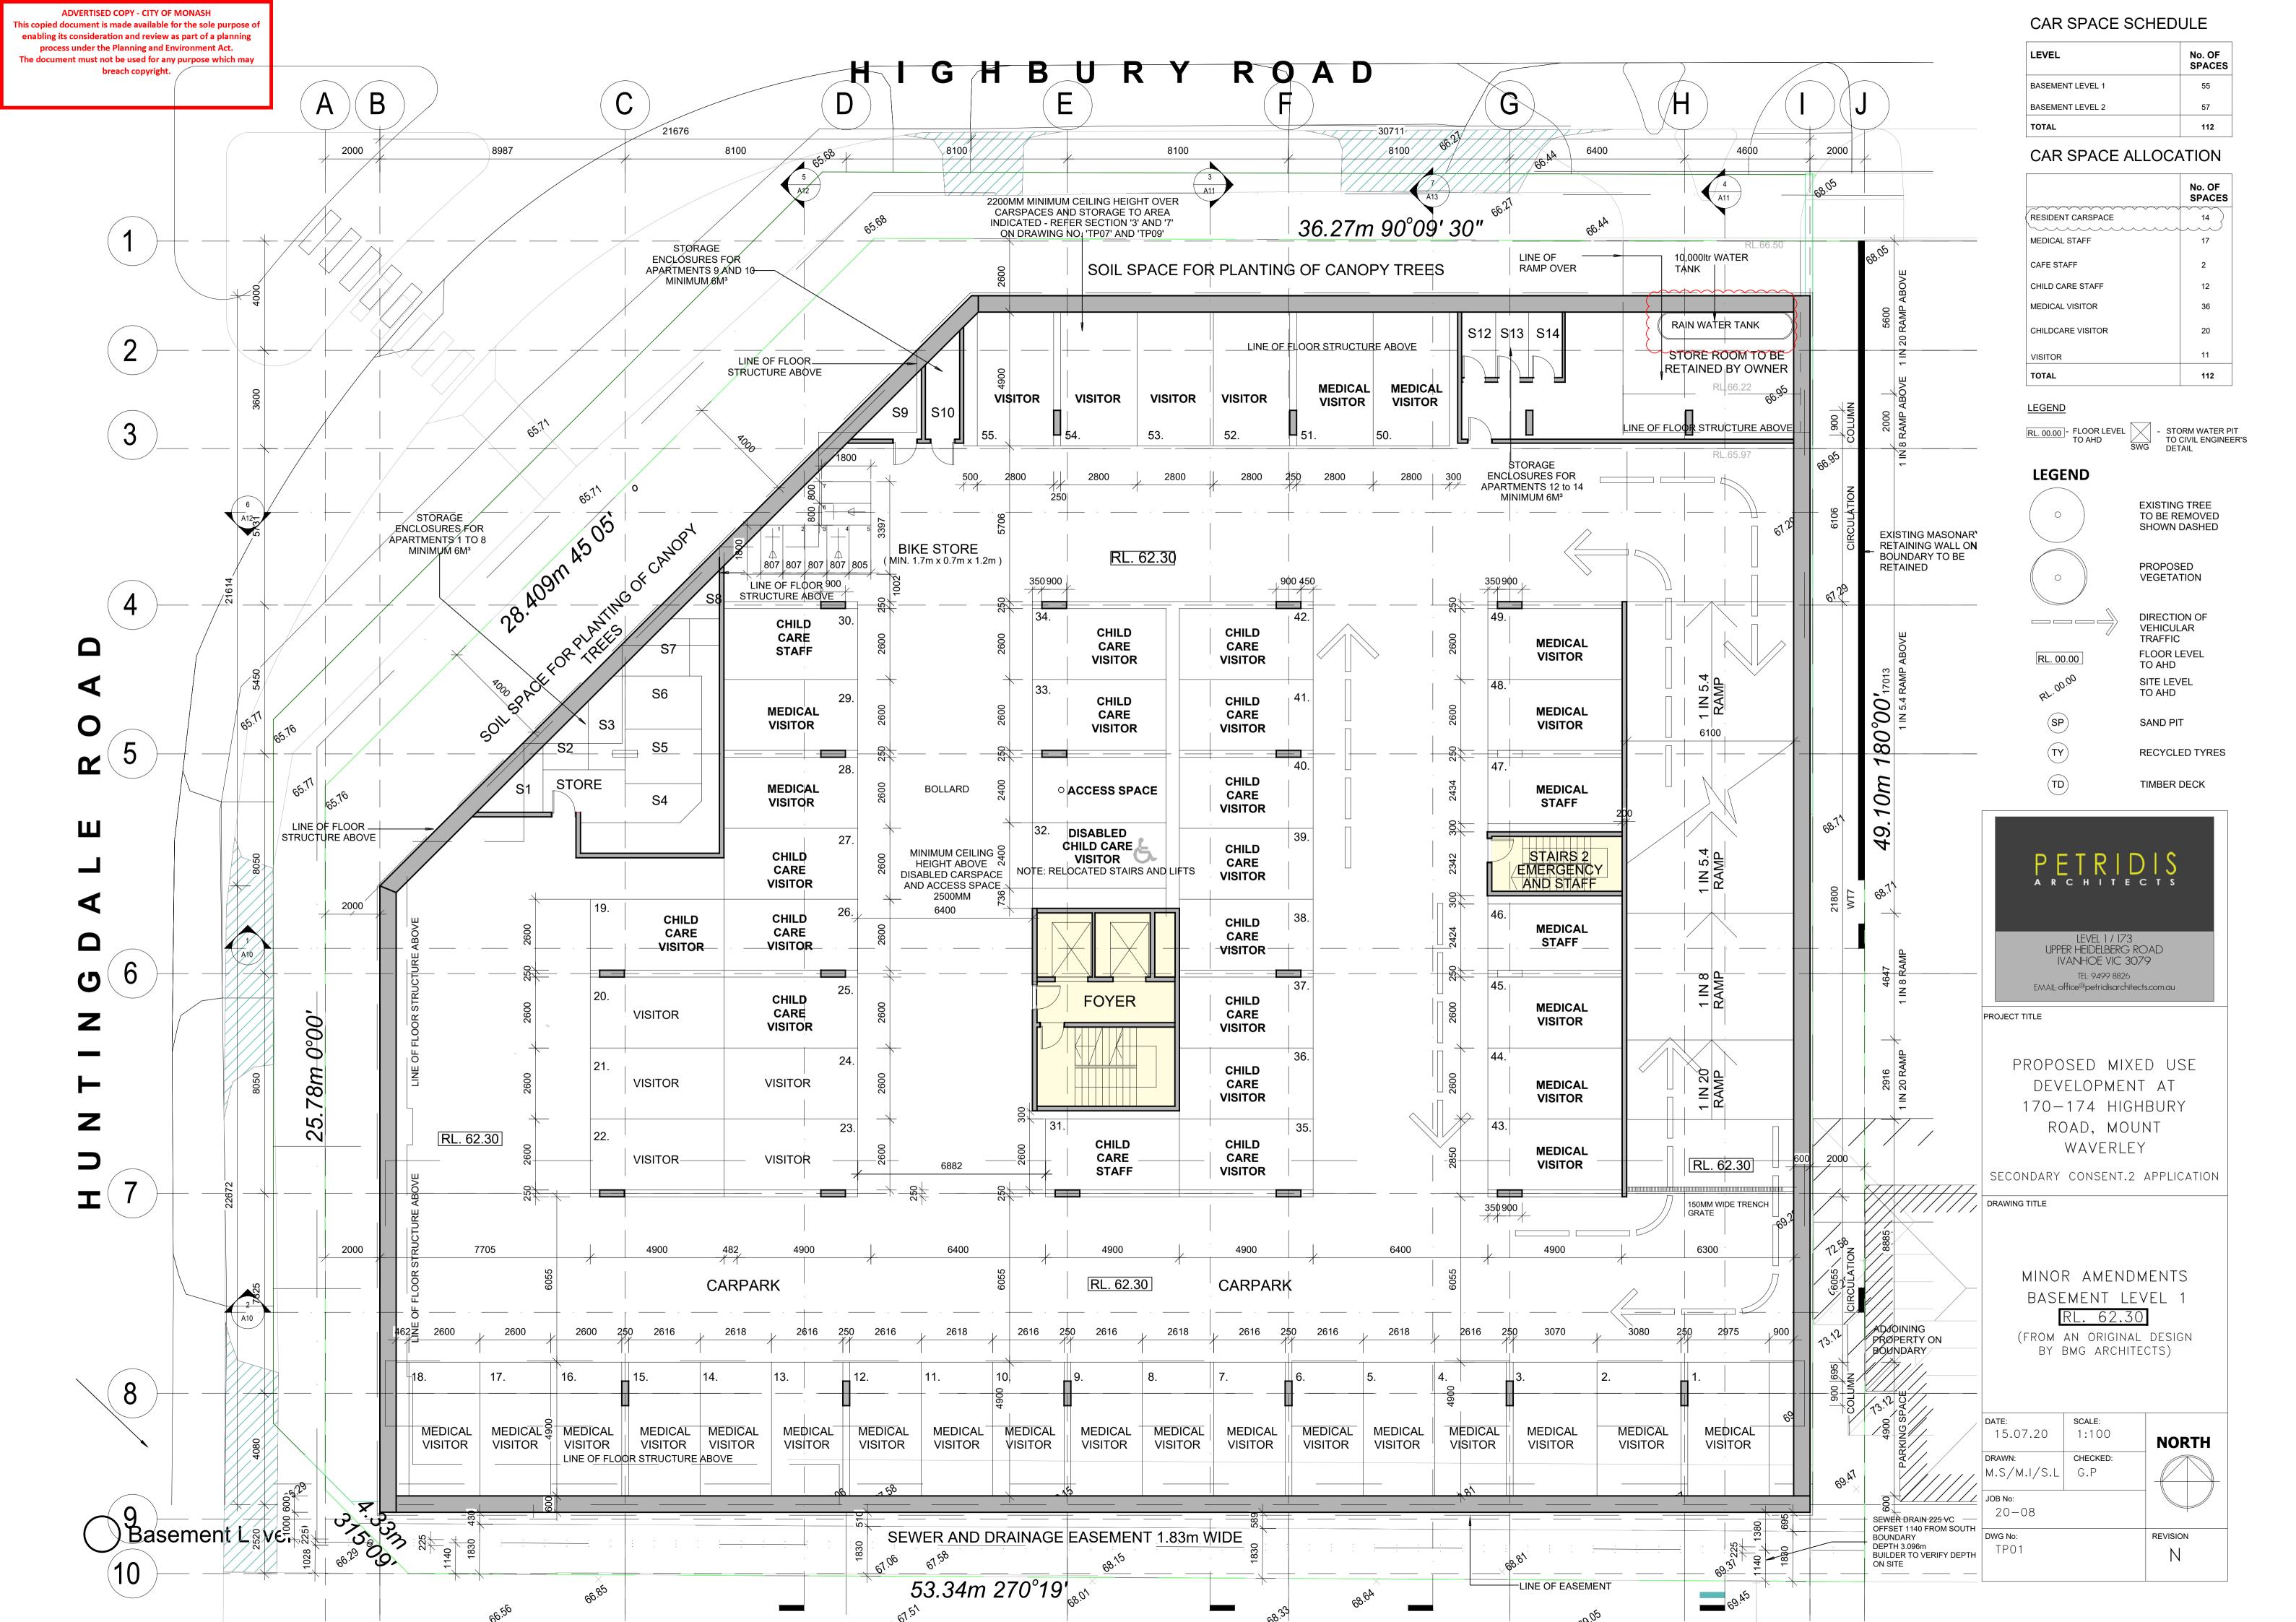

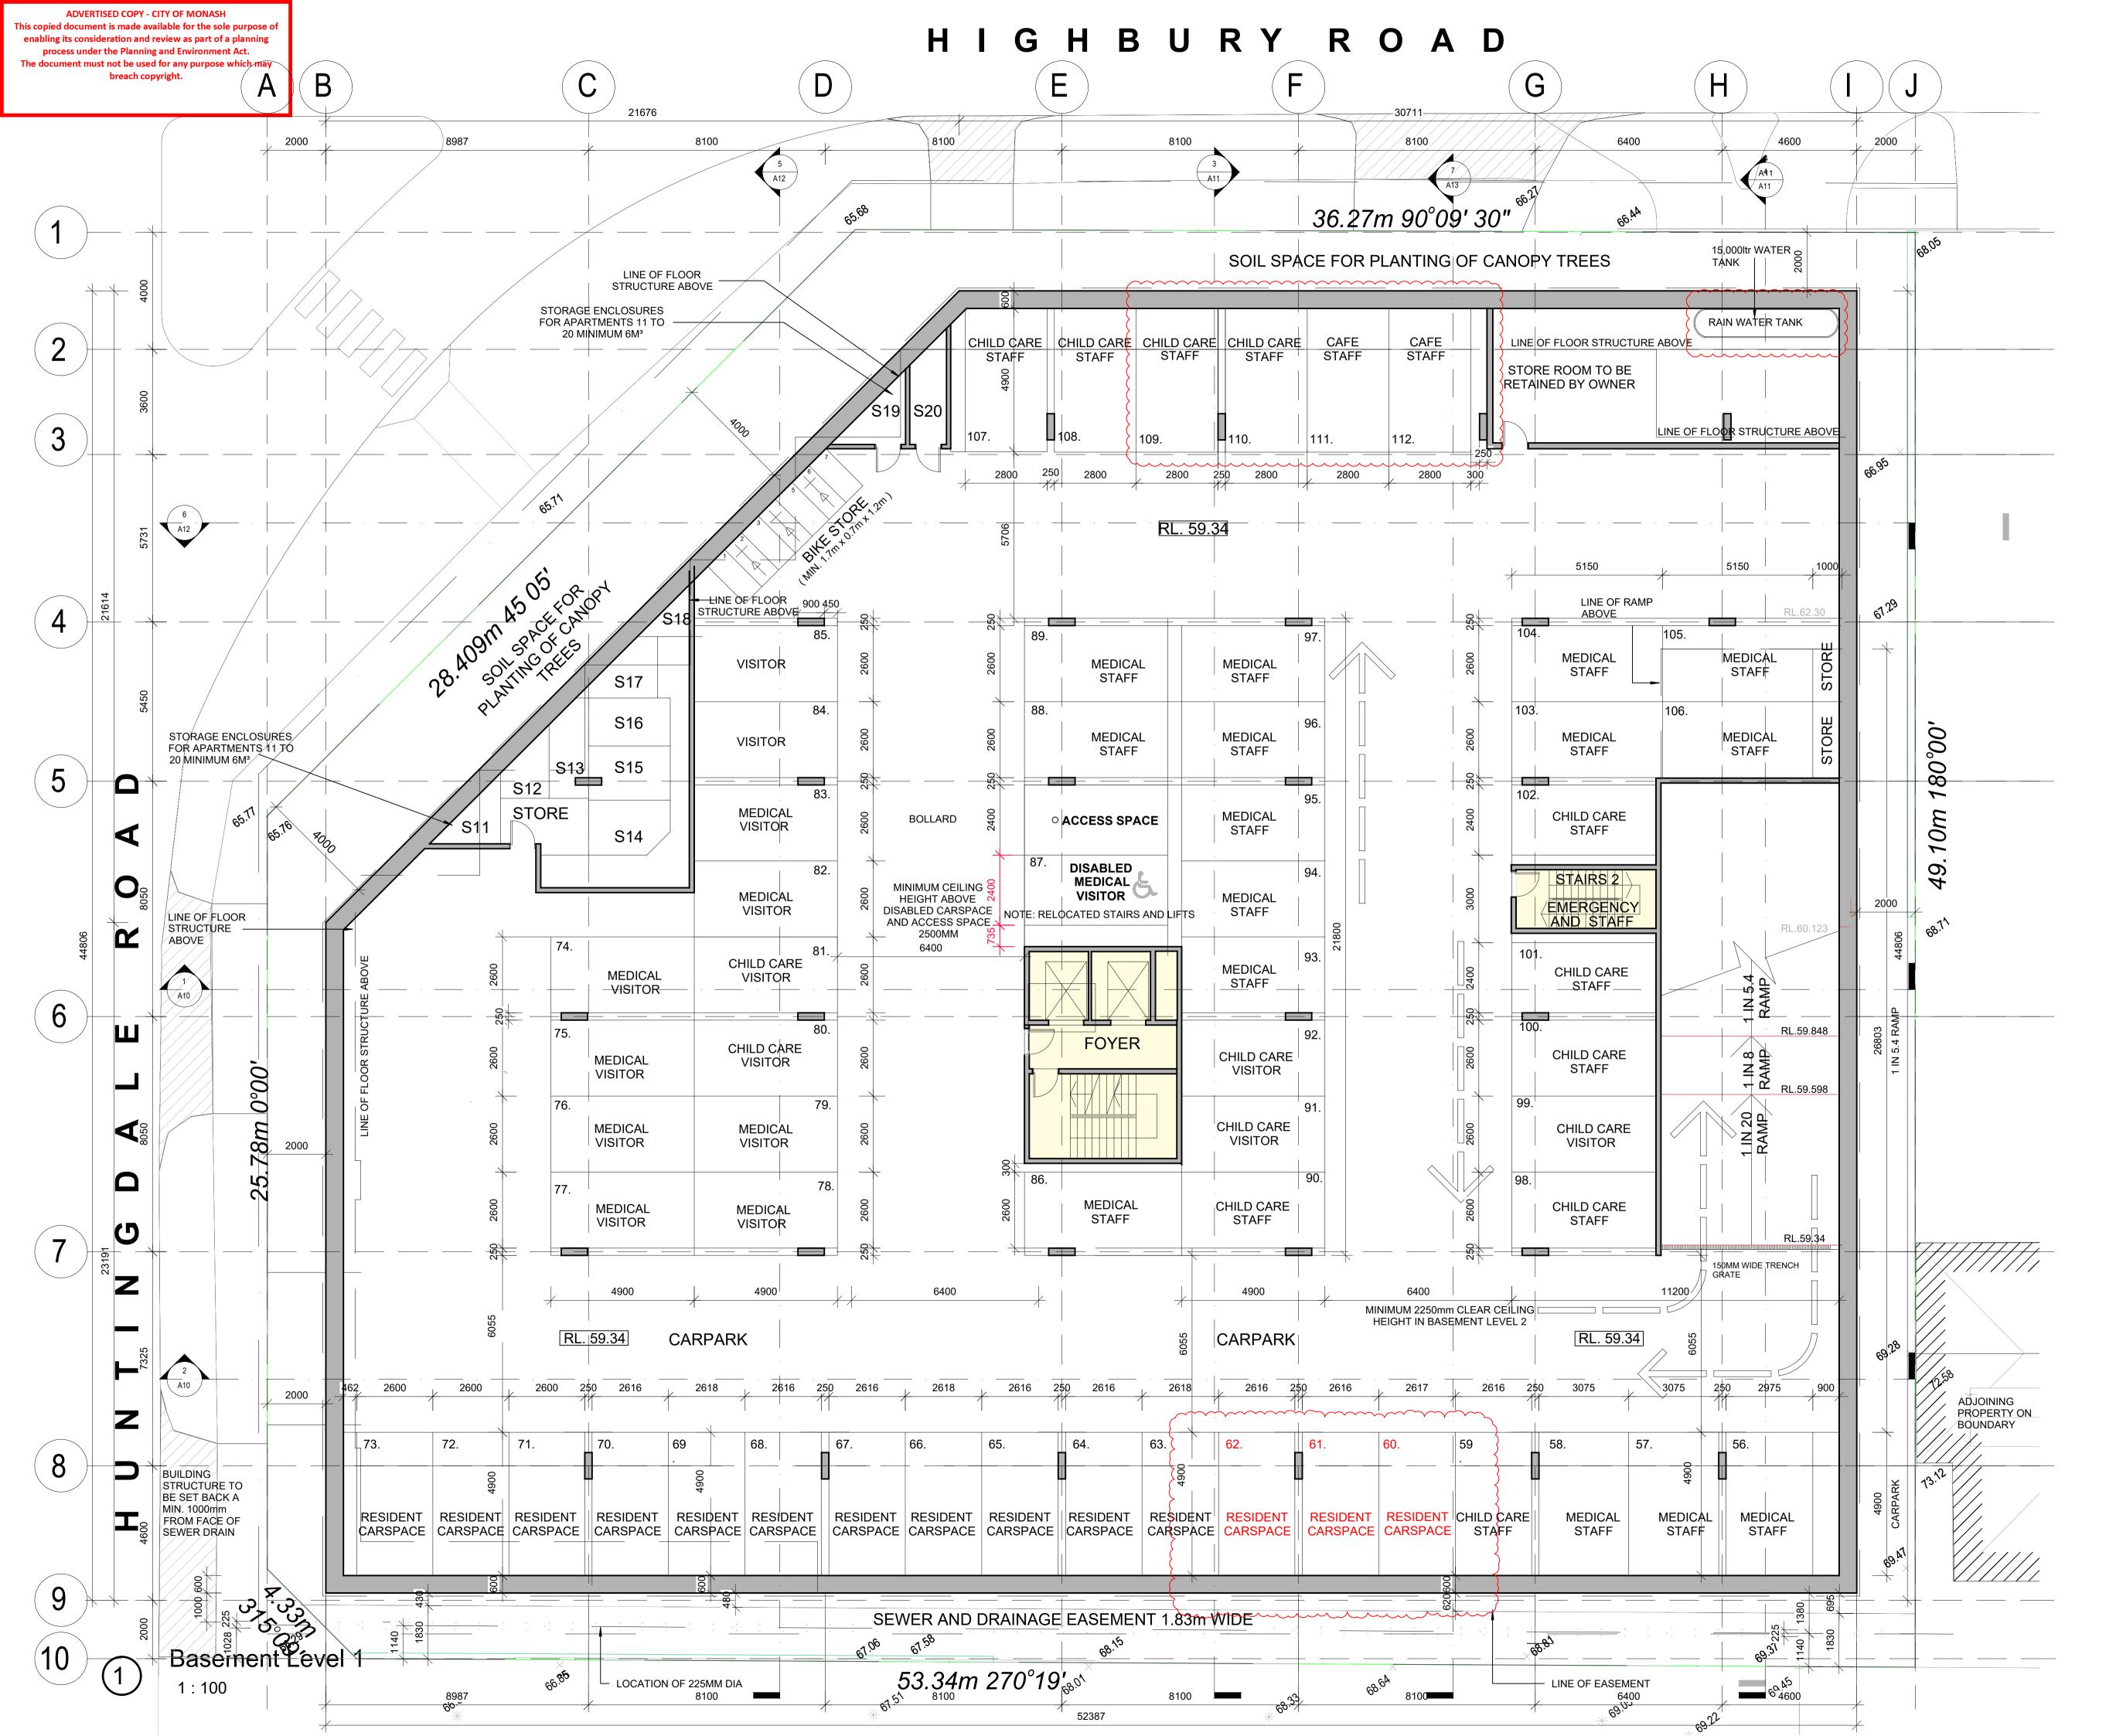

CAR SPACE SCHEDULE

LEVEL	No. OF SPACES
BASEMENT LEVEL 1	55
BASEMENT LEVEL 2	57
TOTAL	112

CAR SPACE ALLOCATION

	No. OF SPACES
RESIDENT CARSPACE	14
MEDICAL STAFF	17
CAFE STAFF	2
CHILD CARE STAFF	12
MEDICAL VISITOR	36
CHILDCARE VISITOR	20
VISITOR	11
TOTAL	112


SWG

<u>LEGEND</u>

TO AHD

RL. 00.00 - FLOOR LEVEL - STORM WATER PIT TO CIVIL ENGINEER'S DETAIL

LEGEND

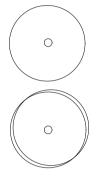

00.00 ar

RL. 00.00

SP TY

TO BE REMOVED SHOWN DASHED

EXISTING TREE

PROPOSED VEGETATION

DIRECTION OF VEHICULAR TRAFFIC FLOOR LEVEL TO AHD SITE LEVEL TO AHD

SAND PIT

RECYCLED TYRES

TIMBER DECK

PETRIDIS ARCHITECTS

LEVEL 1 / 173 UPPER HEIDELBERG ROAD IVANHOE VIC 3079 TEL: 9499 8826 EMAIL: office@petridisarchitects.com.au

PROJECT TITLE


PROPOSED MIXED USE DEVELOPMENT AT 170–174 HIGHBURY ROAD, MOUNT WAVERLEY


SECONDARY CONSENT.2 APPLICATION


DRAWING TITLE

MINOR AMENDMENTS BASEMENT LEVEL 2 RL. 59.34 (FROM AN ORIGINAL DESIGN BY BMG ARCHITECTS)

date : 15.07.20	scale : 1 : 100	NORTH
drawn: M.S/M.I/S.L	CHECKED: G.P	
JOB No: 20-08		
DWG No: TP01A		REVISION

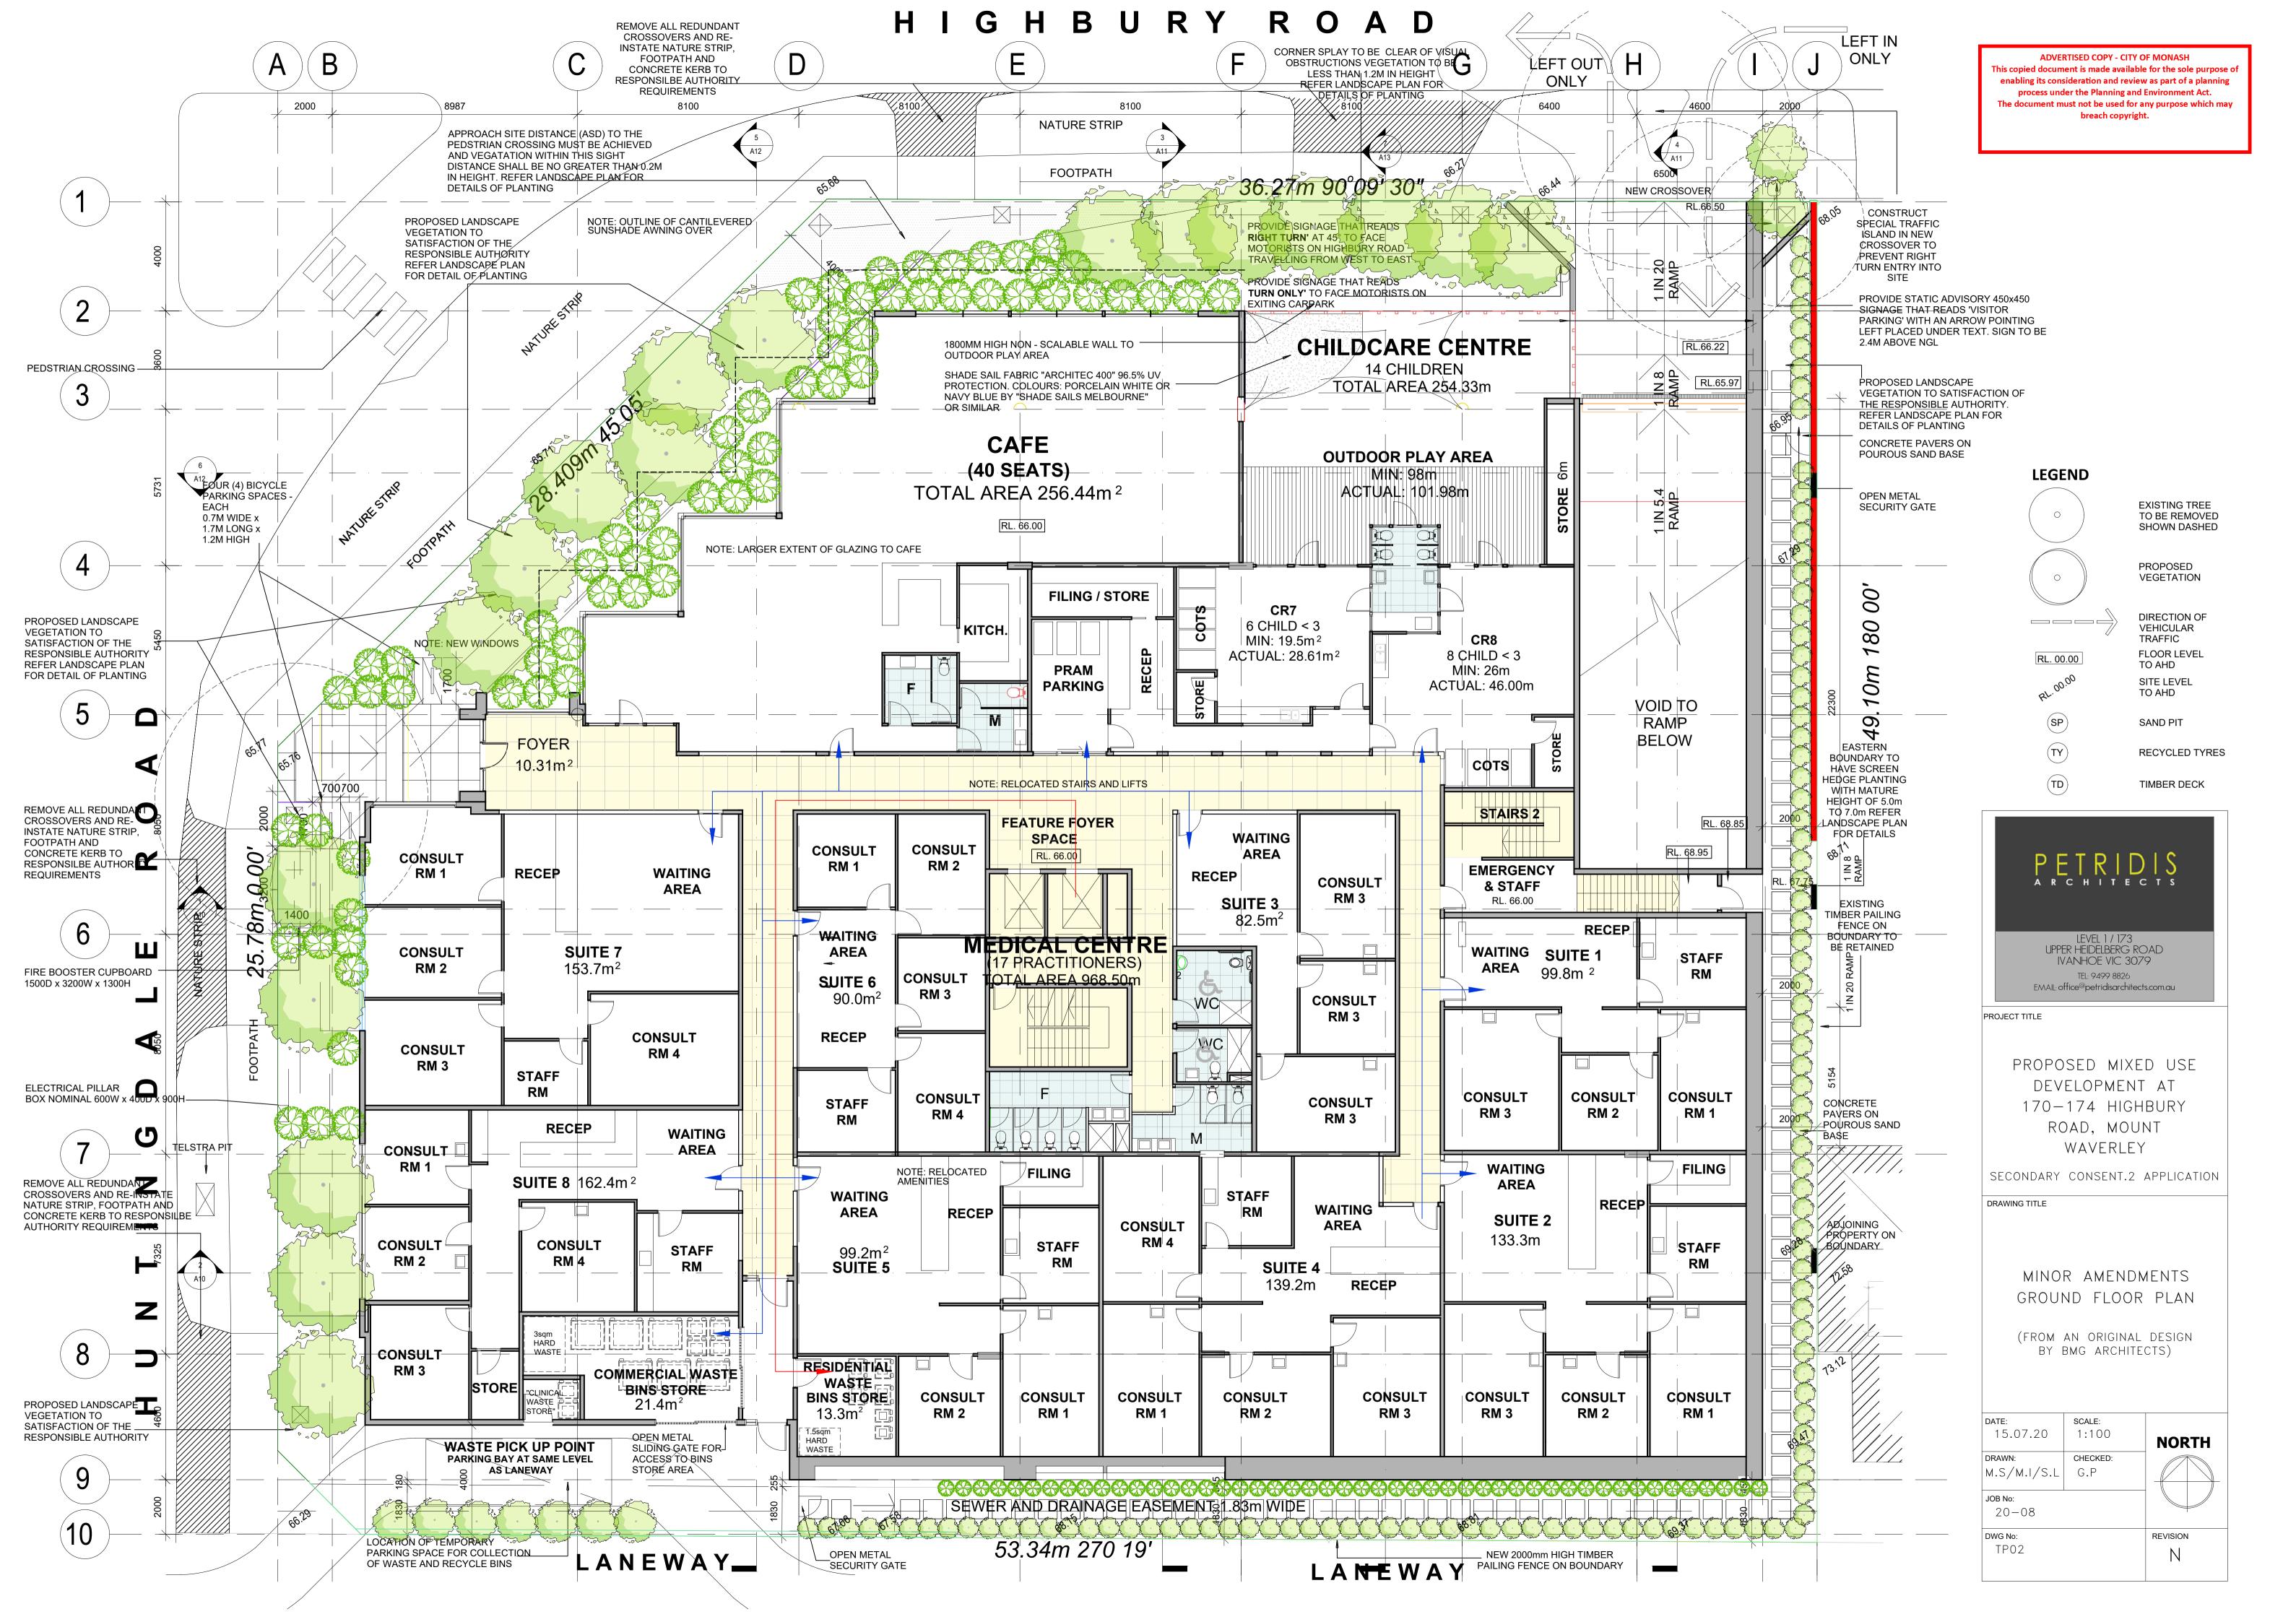

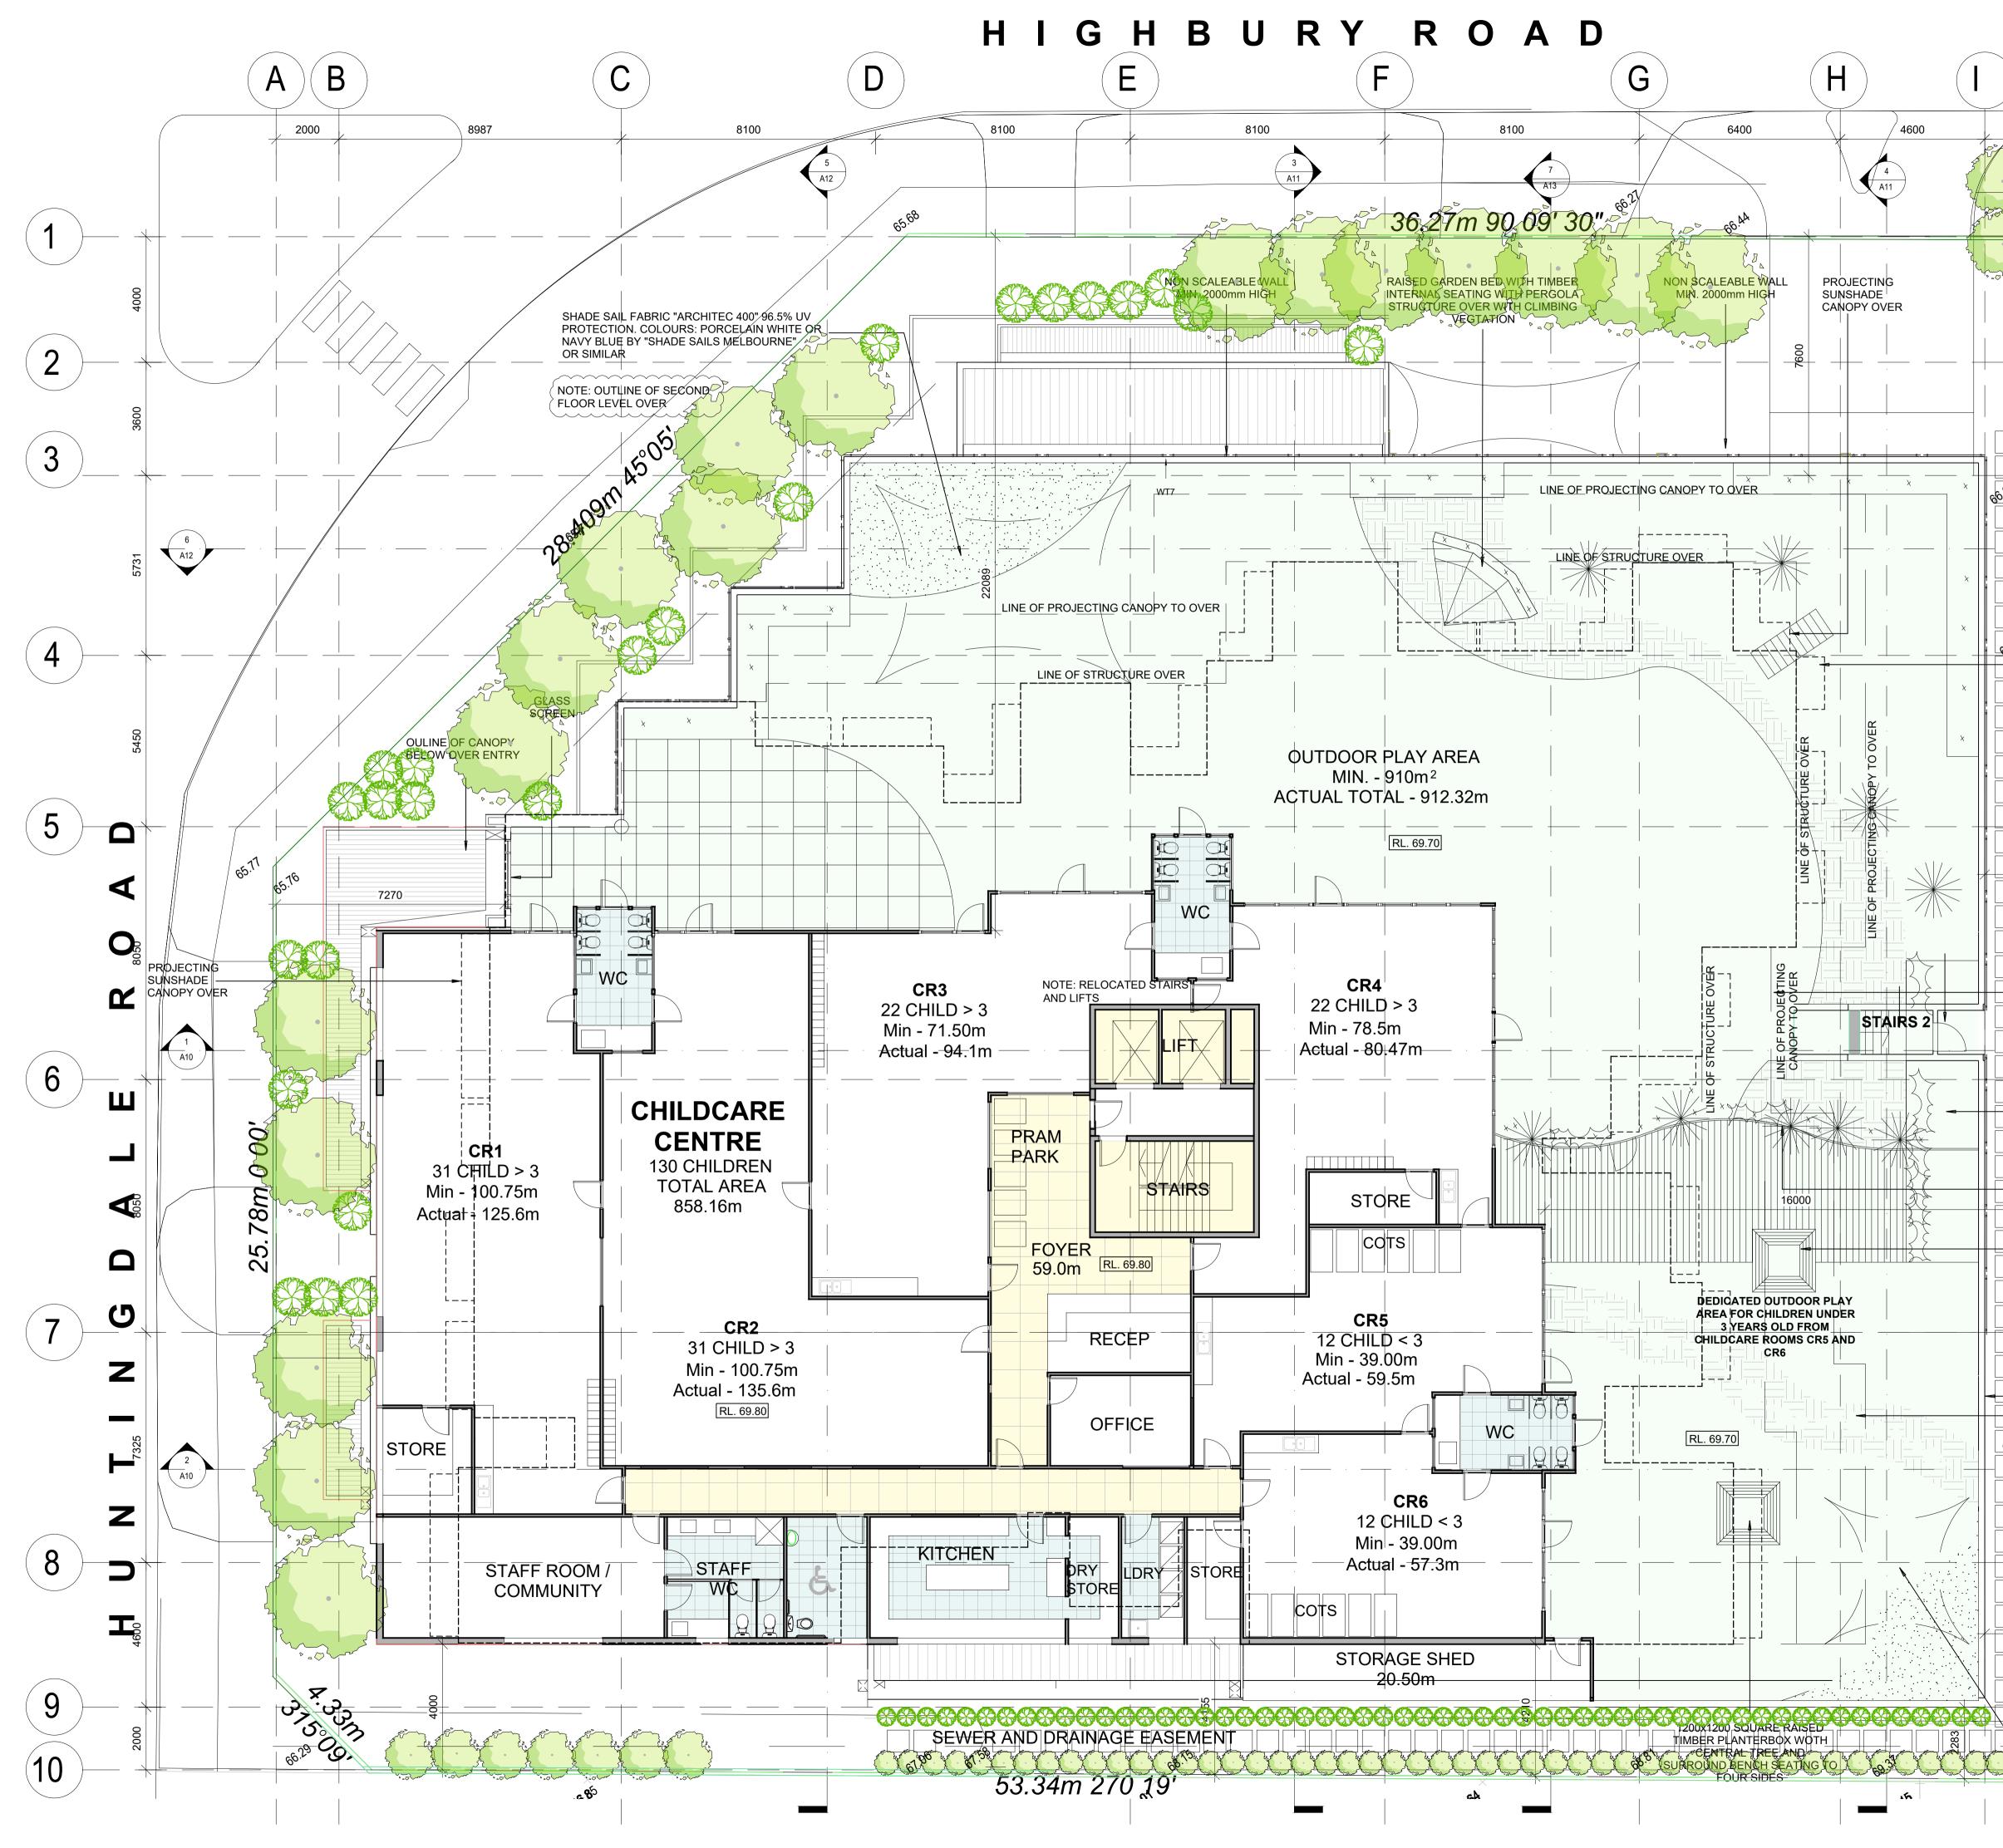

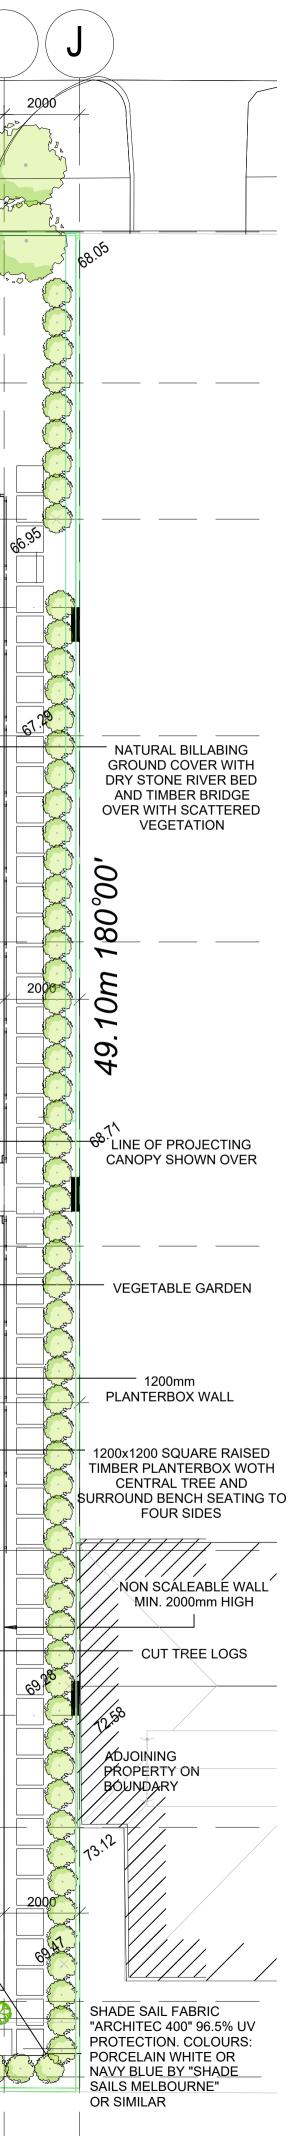

LEGEND

RL. 00.00

(SP) (TY) (TD) EXISTING TREE TO BE REMOVED SHOWN DASHED

PROPOSED VEGETATION

DIRECTION OF VEHICULAR TRAFFIC FLOOR LEVEL TO AHD SITE LEVEL TO AHD

SAND PIT

RECYCLED TYRES

TIMBER DECK

PETRIDIS A R C H I T E C T S

LEVEL 1 / 173 UPPER HEIDELBERG ROAD IVANHOE VIC 3079 TEL: 9499 8826 EMAIL: office@petridisarchitects.com.au

PROJECT TITLE

PROPOSED MIXED USE DEVELOPMENT AT 170-174 HIGHBURY ROAD, MOUNT WAVERLEY

SECONDARY CONSENT.2 APPLICATION

DRAWING TITLE

MINOR AMENDMENTS FIRST FLOOR PLAN

DATE: 15.07.20	scale: 1:100	NORTH
drawn: M.S/M.I/S.L	CHECKED: G.P	
JOB No: 20-08		
dwg № : TP03		




FULL WIDTH AND FULL HEIGHT

	ARI	EA	'n			
)	STAIRS / I	LIFTS	38.90			
	соммон	AREAS	91.50			
	DWELLIN	GS				
	UNIT NO.	BEDS	BATHS	LIVING	TERRACE	TOTAL
	1	2 + study	2	94.60	23.30	117.90
	2	2	1	88.30	25.70	114.00
	3	1	1	57.90	12.00	69.90
	4	1 + study	1	64.70	9.30	74.00
	5	2	1	74.33	13.50	87.83
	6	1	1	51.00	8.10	59.10
	7	2	1	76.70	15.60	92.30
	8	2	2	82.40	12.40	94.80
	9	2	2	81.20	29.10	110.30
	10	2	2	87.70	11.50	99.20
	11	2	2	71.50	13.00	84.50
	12	 1 + study		64.70	9.50	74.20
	12	1	1	50.00	8.00	69.50
	14	2	1	78.50	22.70	100.70
		ING TOTA		. 0.00	22.10	1023.53
	TOTAL		· -		1248	3.23 m ²
CANOPY TO PROTECT CHILDREN FROM FALLING OBJECTS AND TO PROVIDE PRIVACY			ARC	н I Т EVEL 1 / 17	D S E C T S	
			IVANI TE	HOE VIC 11: 9499 882	3079	
	P	ROJECT TIT	LE			
LDRY			DEVEL 70–17 ROAI	ορμε		
		SECONI	DARY CC	NSENT	.2 APPL	ICATION
<i> </i>						
ADJOINING PROPERTY ON BOUNDARY		Drawing Ti	TLE			
PROPERTY ON		М	INOR .		DMENT DR PL/	
PROPERTY ON BOUNDARY		M Se	INOR COND Rom an	FLO(ΔN
PROPERTY ON BOUNDARY		M SE (FF 2 5. 07.	INOR COND ROM AN BY BMC 20 1	FLO ORIGIN ARCH	OR PL	ΔN
PROPERTY ON BOUNDARY		M Se (ff	INOR COND ROM AN BY BMC 20 1 cf	FLO ORIGIN ARCH	OR PL	A N IGN
PROPERTY ON BOUNDARY		M SE (FF 15.07. DRAWN:	INOR COND ROM AN BY BMC 20 1 CH /S.L G	FLO ORIGIN ARCH ALE: :100	OR PL	A N IGN


2000

2000

2000 🔨

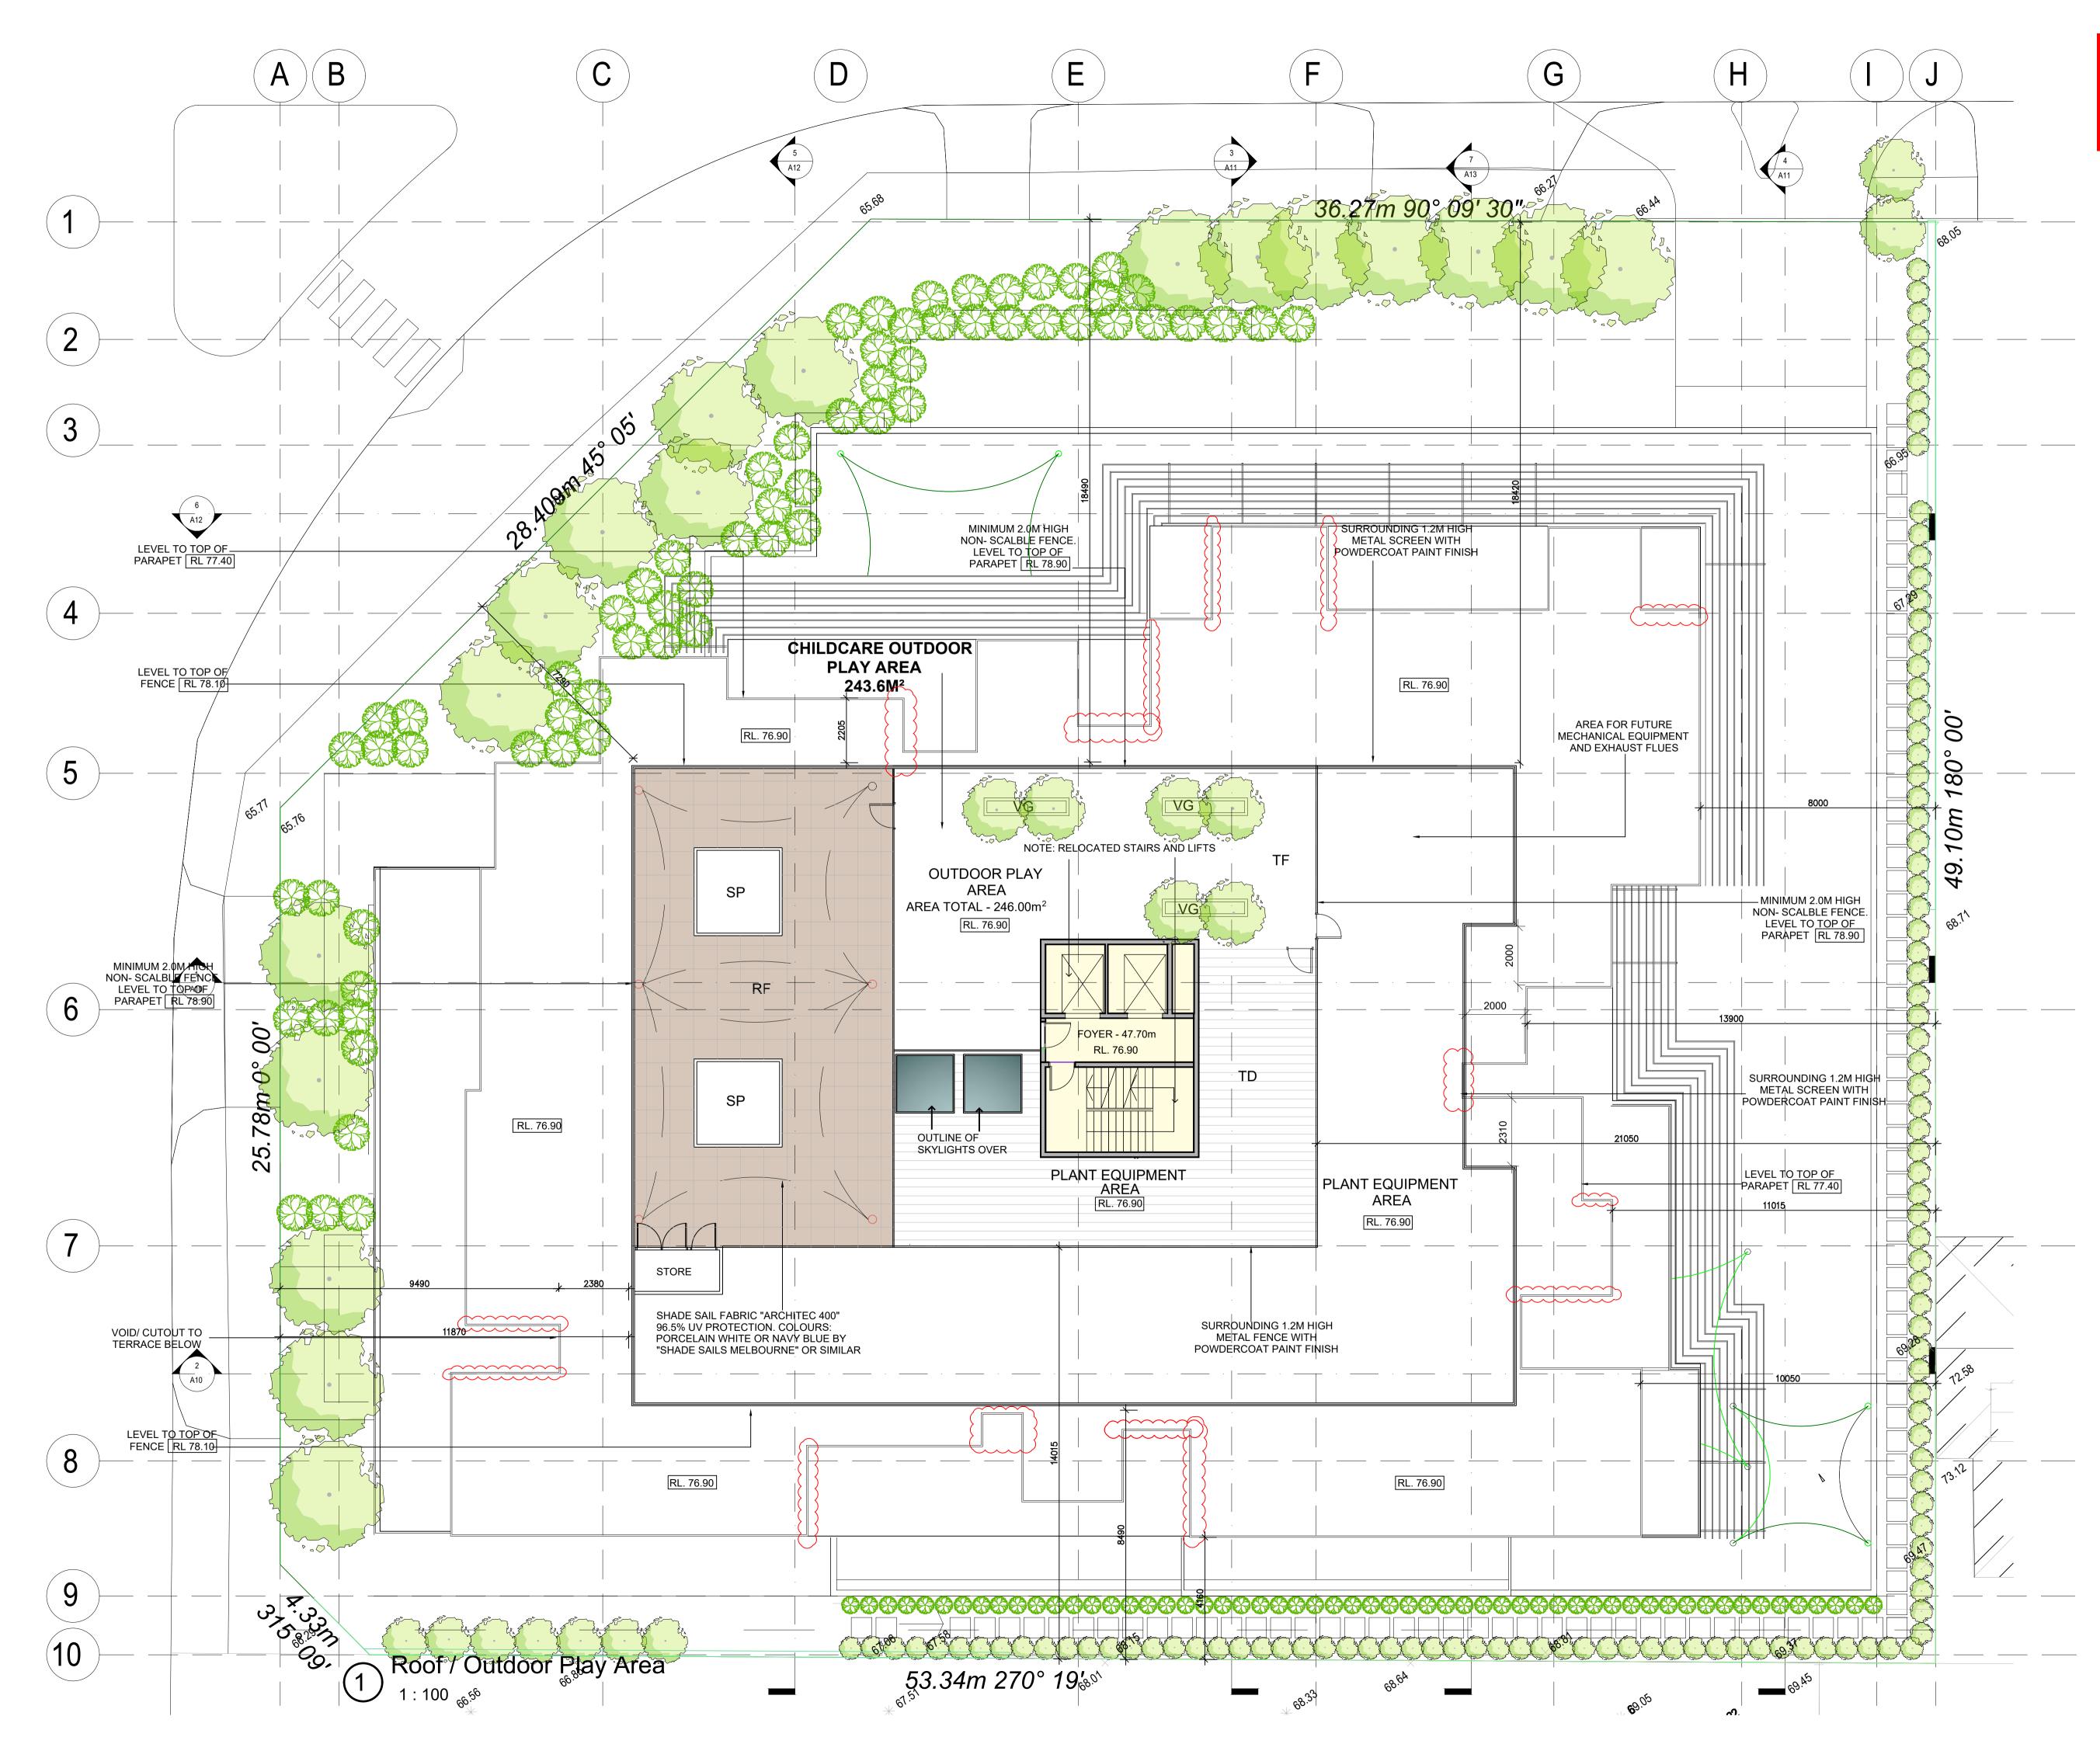

LEGEND

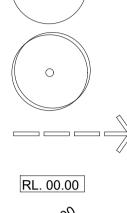

RF (00,00 (SP) (TY) (TD) (RF) (TF)

0

EXISTING TREE TO BE REMOVED SHOWN DASHED

PROPOSED VEGETATION

DIRECTION OF VEHICULAR TRAFFIC FLOOR LEVEL TO AHD SITE LEVEL

TO AHD

RECYCLED TYRES

TIMBER DECK

SOFT IMPACT RUBBER FLOORING

ARTIFICIAL TURF

SUPPORT POST FOR SUNSHADE

PETRIDIS ARCHITECTS

LEVEL 1 / 173 UPPER HEIDELBERG ROAD IVANHOE VIC 3079 TEL: 9499 8826 EMAIL: office®petridisarchitects.com.au

PROJECT TITLE


PROPOSED MIXED USE DEVELOPMENT AT 170-174 HIGHBURY ROAD, MOUNT WAVERLEY

SECONDARY CONSENT.2 APPLICATION


DRAWING TITLE


MINOR AMENDMENTS ROOF PLAN

DATE: 15.07.20	scale : 1:100	NORTH
drawn: M.S/M.I/S.L	checked: G.P	
JOB No: 20-08		
dwg № : TP03B		

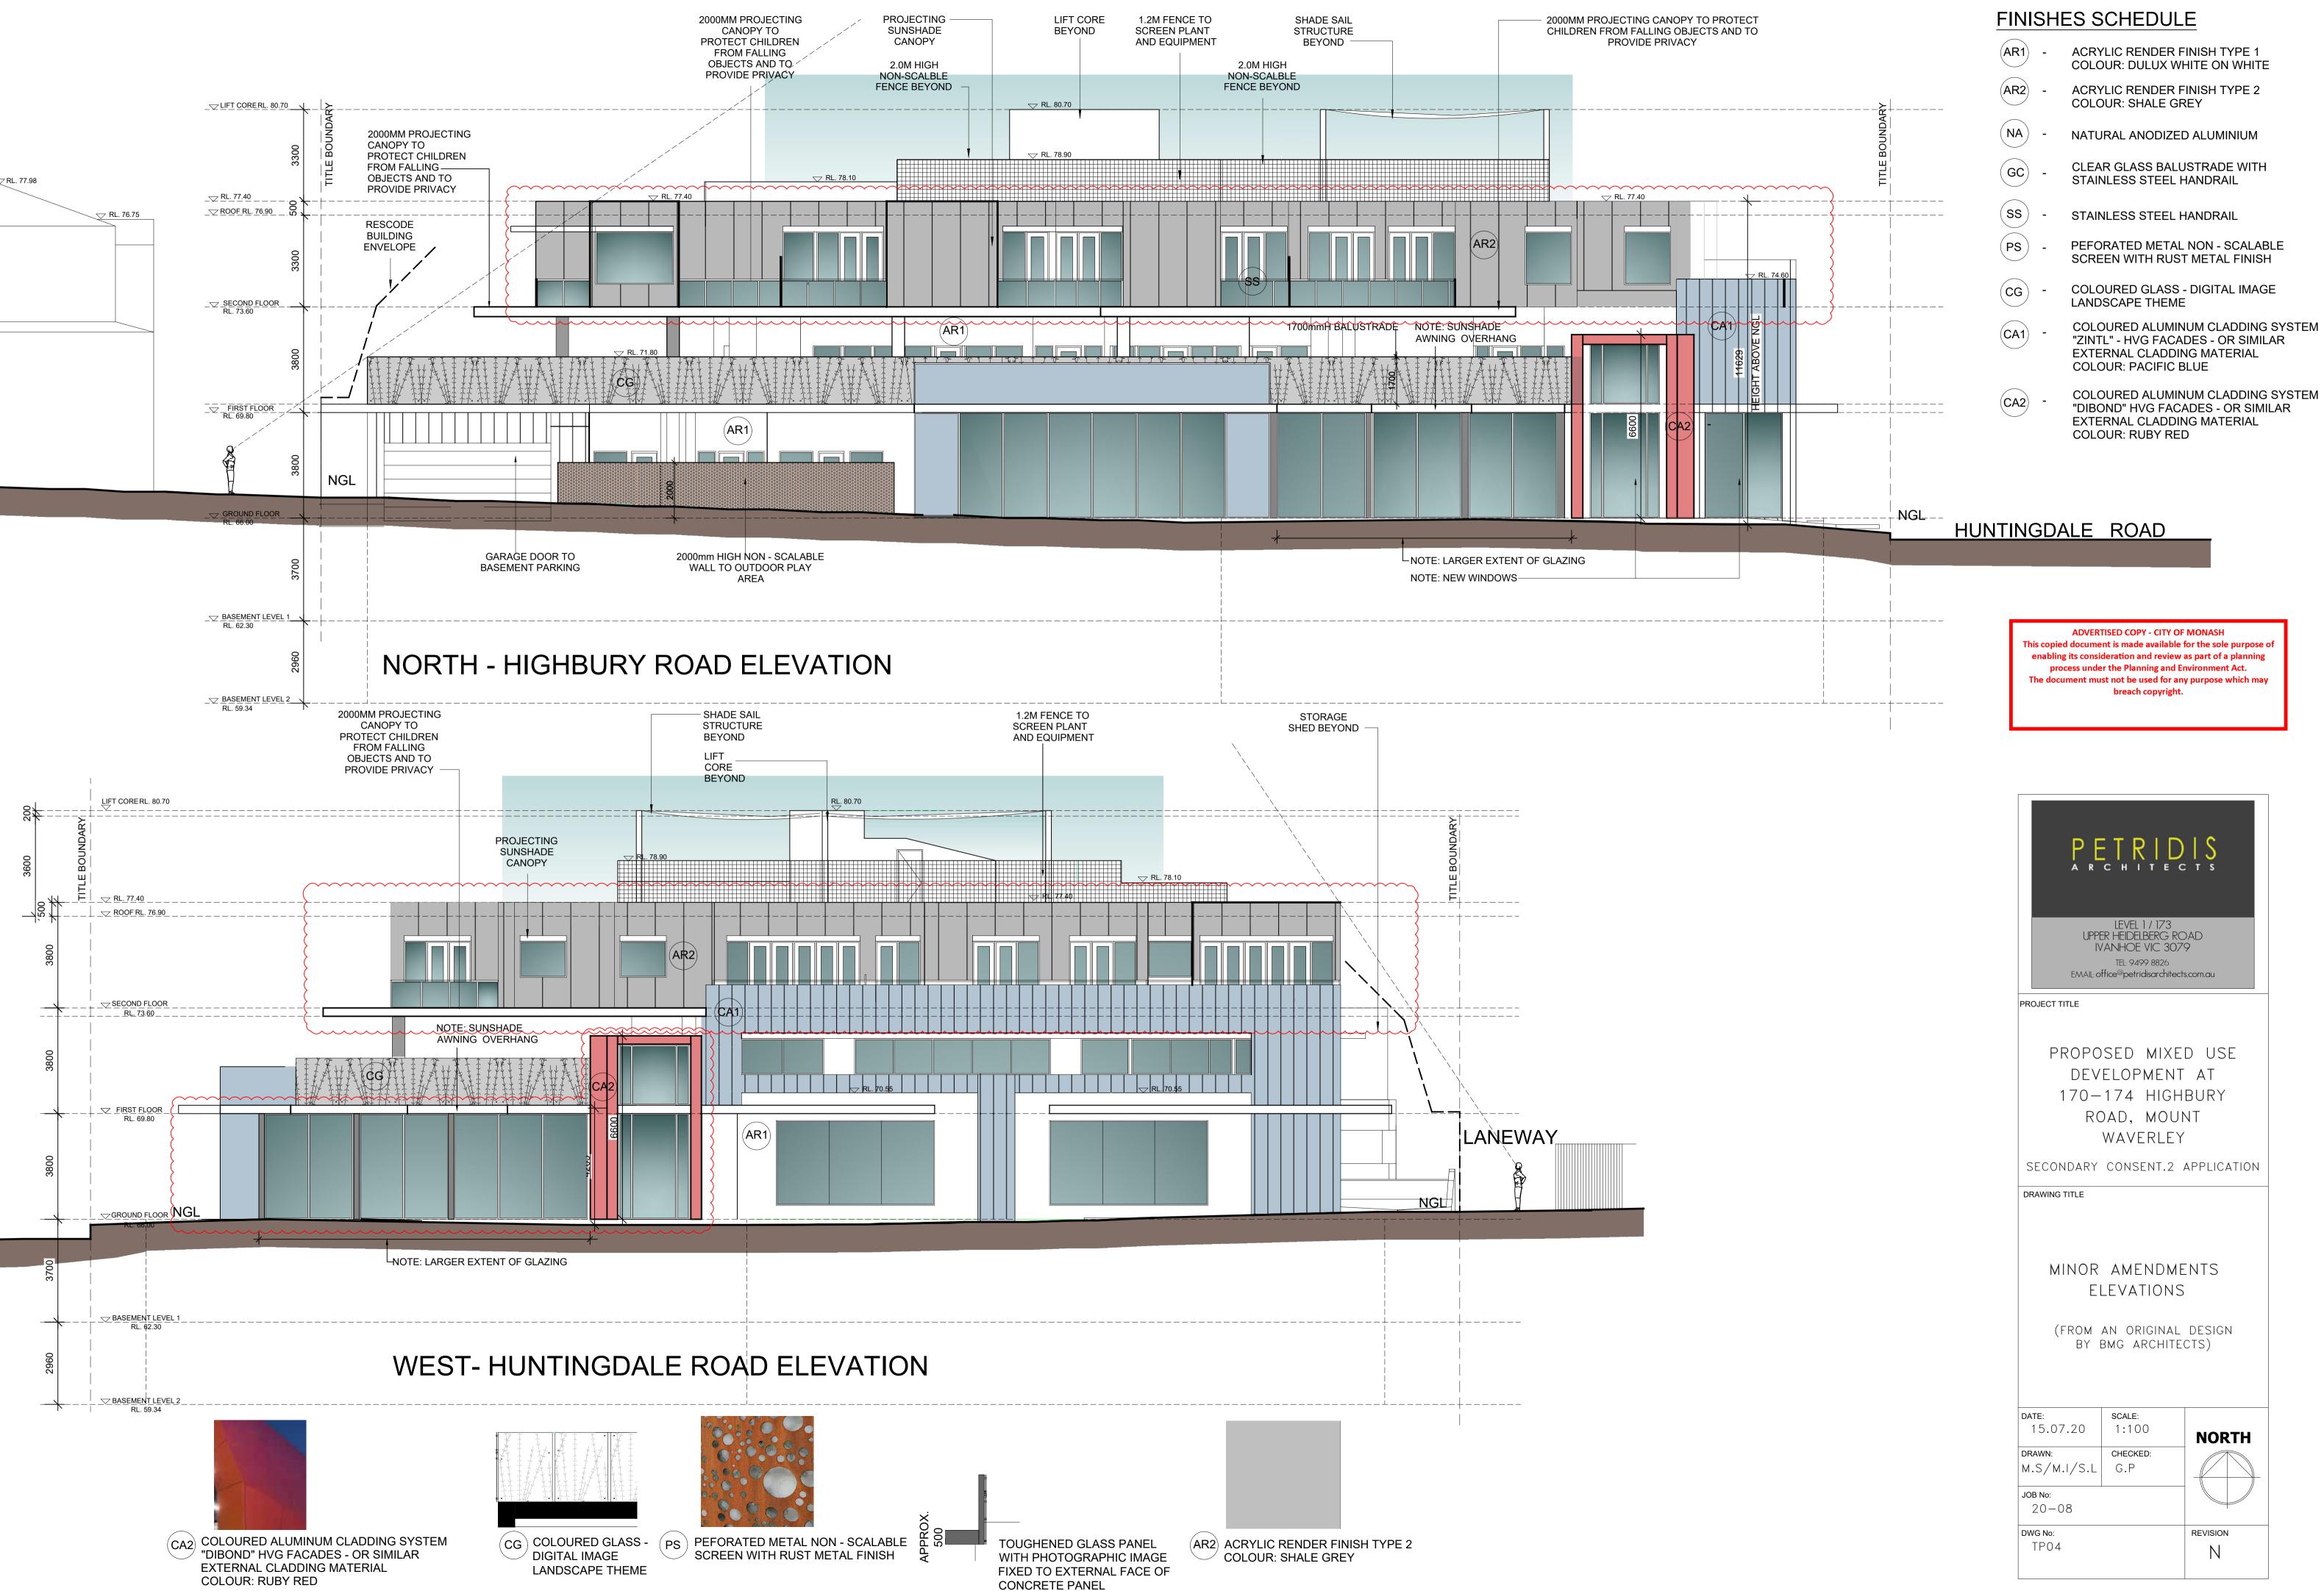

LEVEL 1 / 173 UPPER HEIDELBERG RC IVANHOE VIC 307 TEL: 9499 8826 EMAIL: office@petridisarchitects	9
PROJECT TITLE	
PROPOSED MIXE DEVELOPMENT 170—174 HIGH ROAD, MOUN WAVERLEY	AT BURY NT
SECONDARY CONSENT.2 /	APPLICATION
drawing title MINOR AMENDME ELEVATIONS	
(FROM AN ORIGINAL BY BMG ARCHITE	DESIGN
DATE: SCALE: 15.07.20 1:100 DRAWN: CHECKED: M.S/M.I/S.L G.P JOB No: Comparison of the second	NORTH
20-08	+
DWG No: TP04	

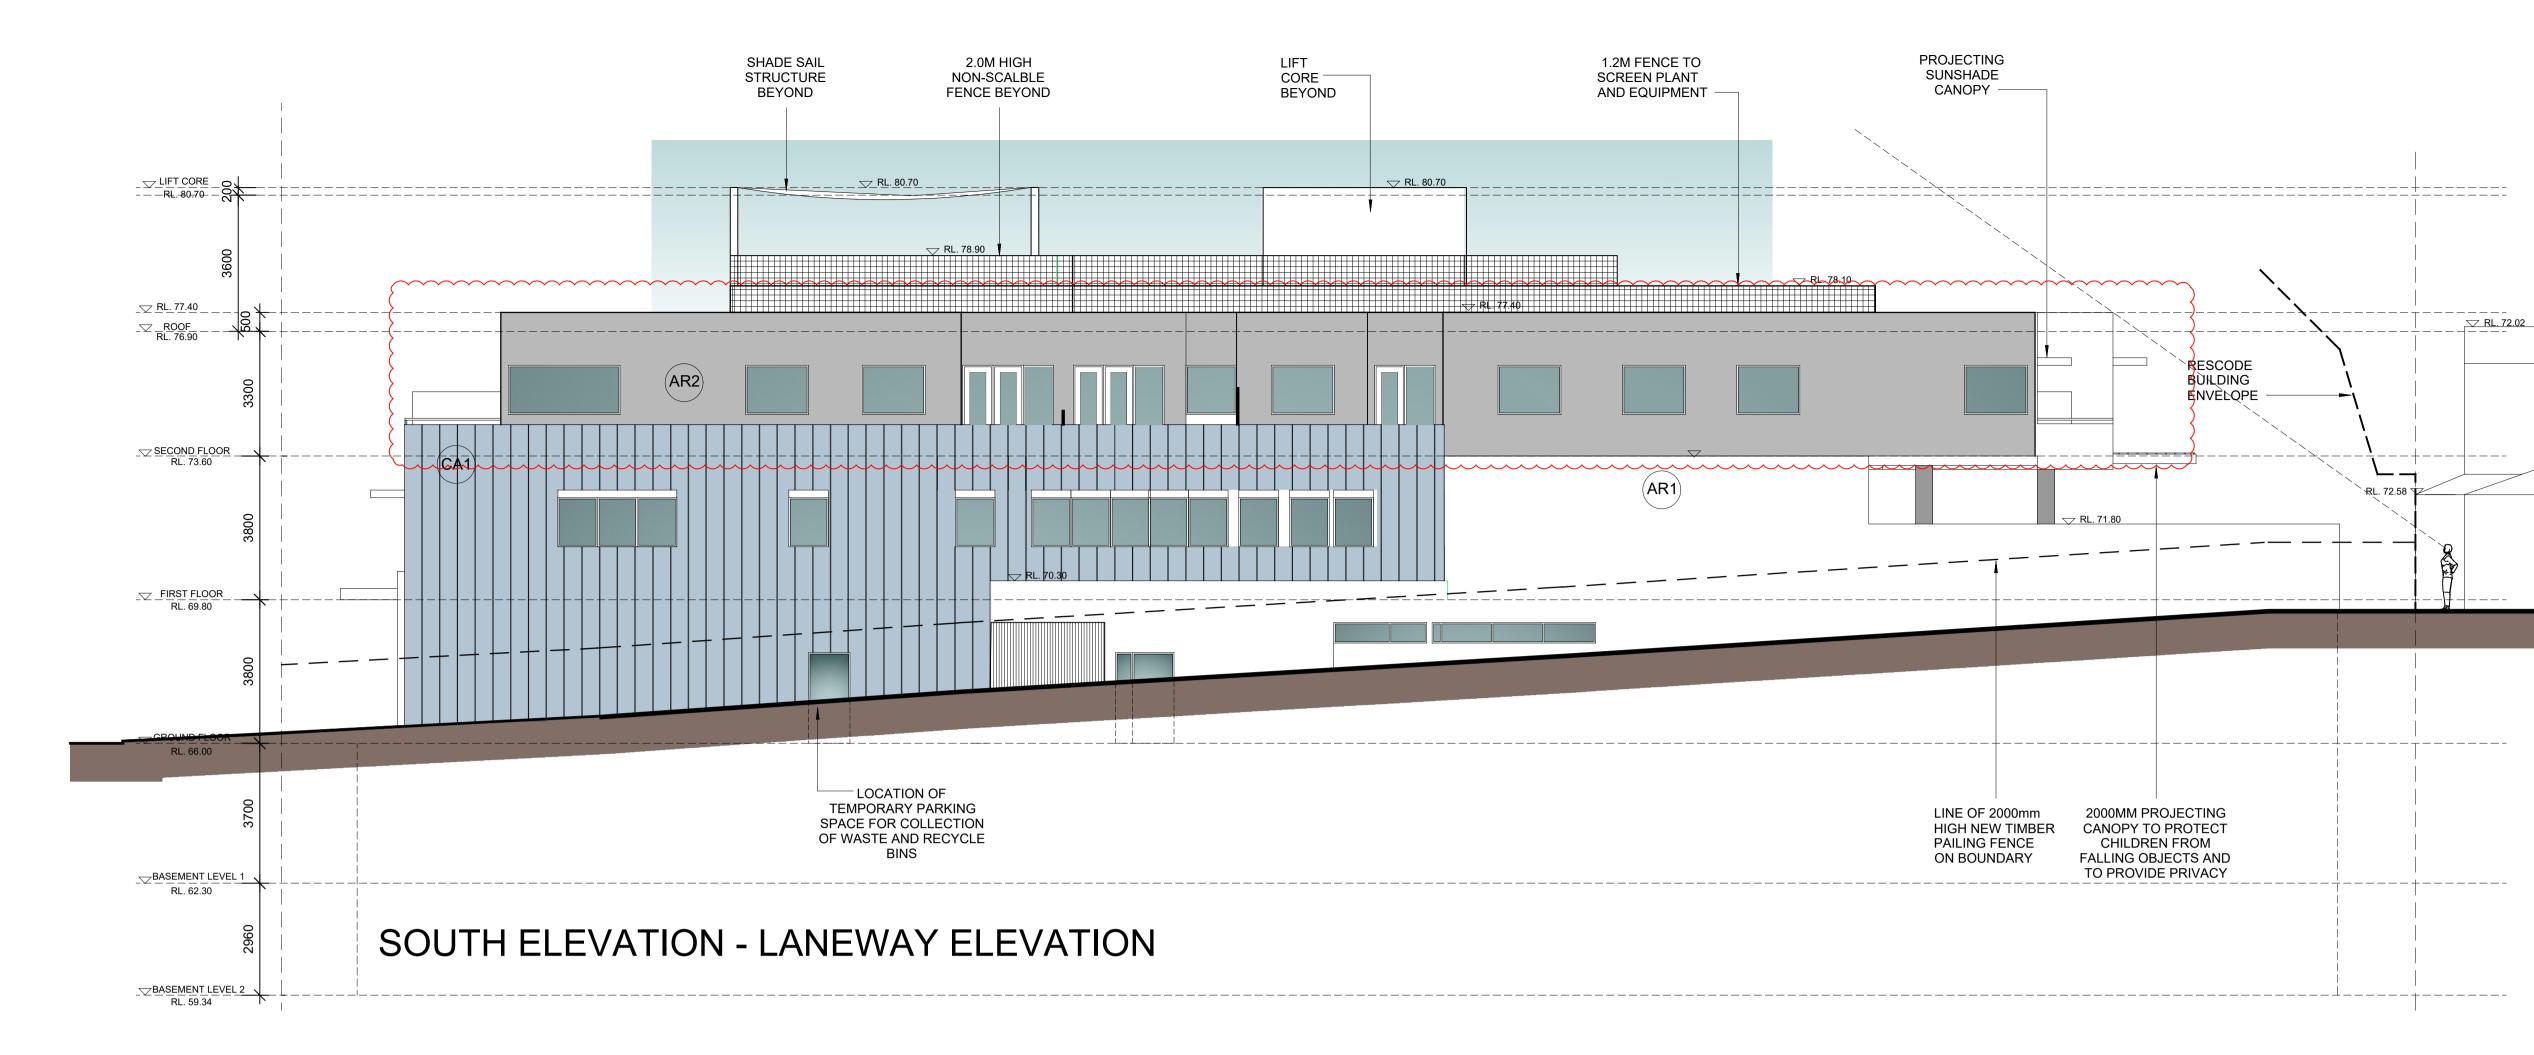

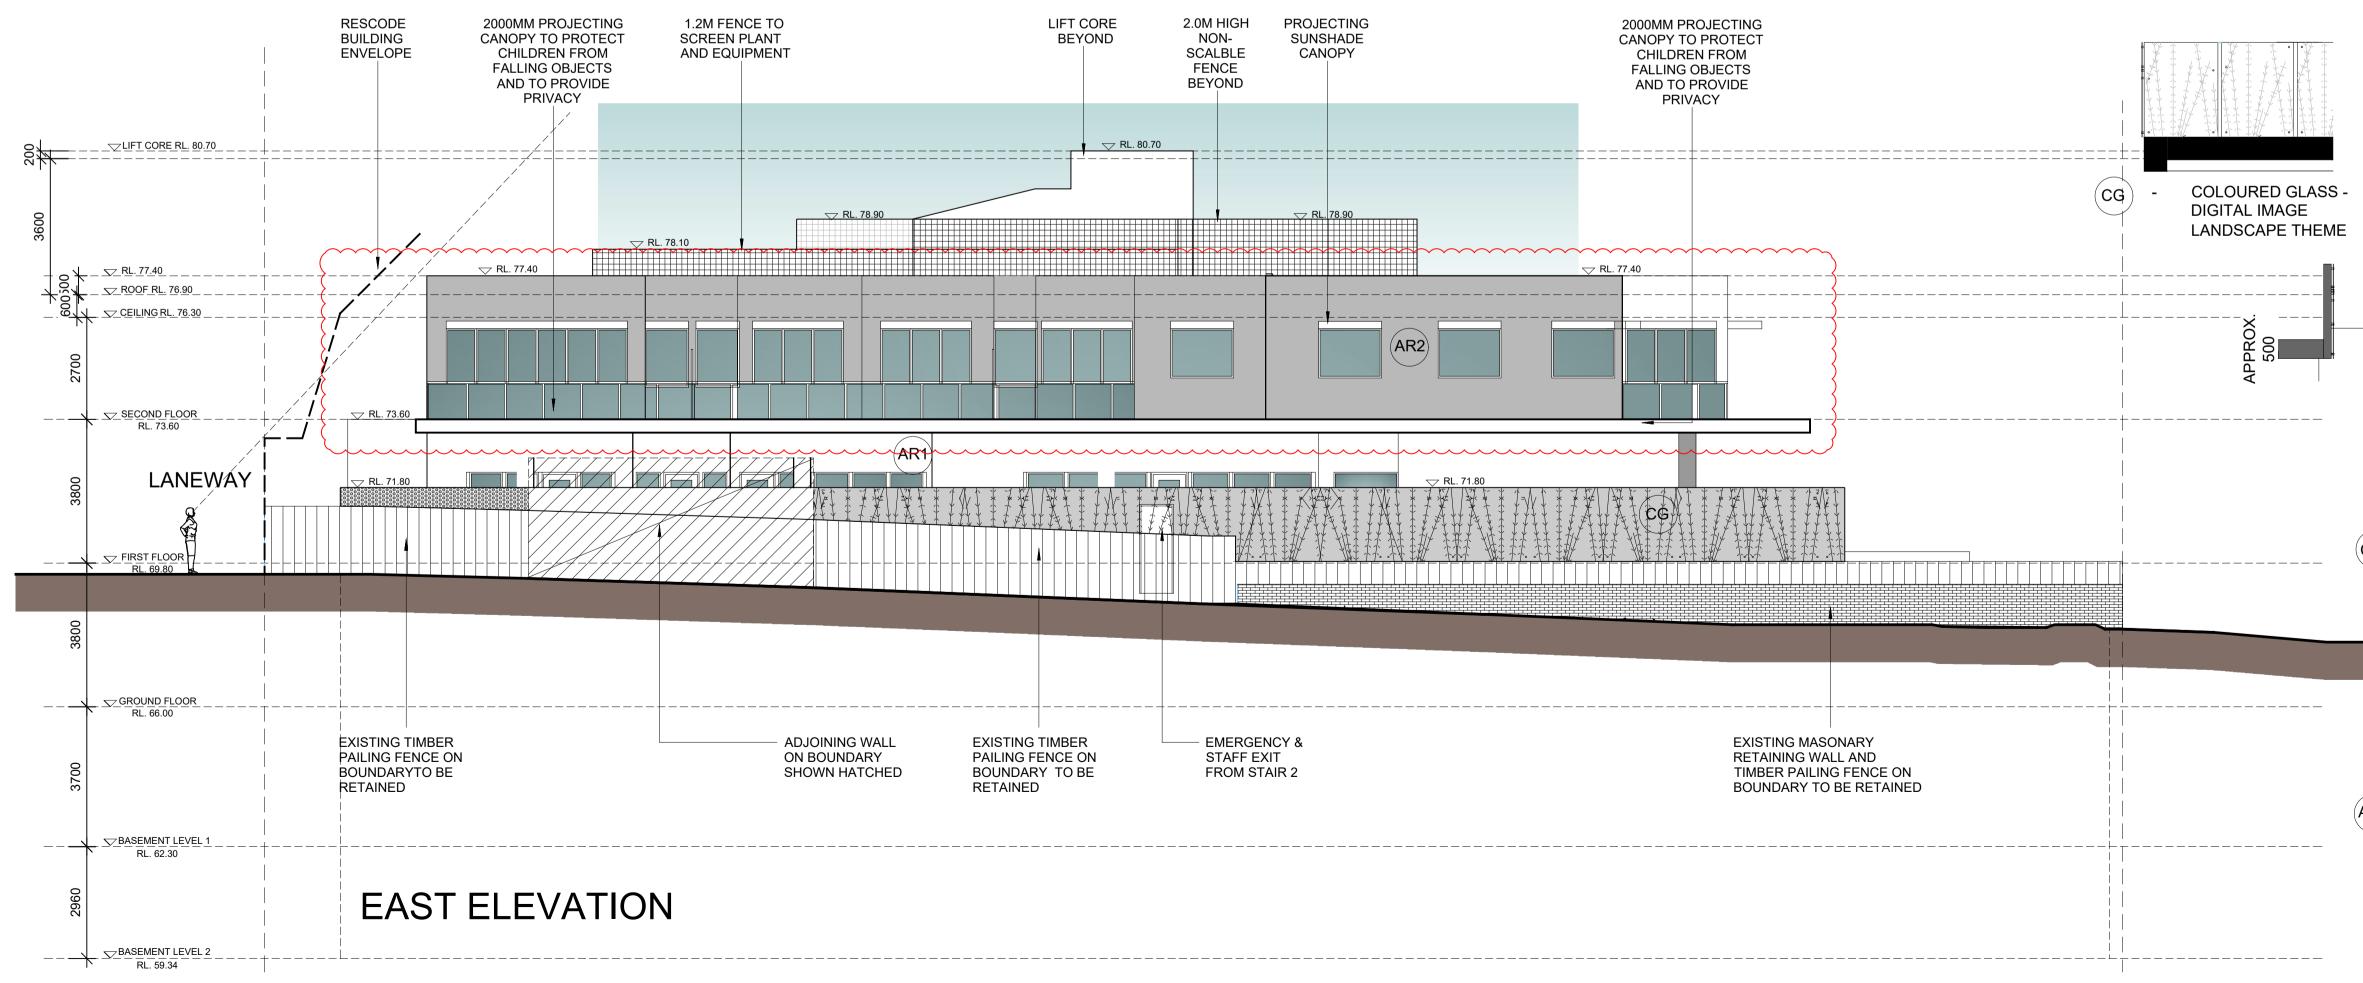

FINISHES SCHEDULE

- AR1 ACRYLIC RENDER FINISH TYPE 1 COLOUR: DULUX WHITE ON WHITE
 AR2 - ACRYLIC RENDER FINISH TYPE 2
 - COLOUR: SHALE GREY
- (NA) NATURAL ANODIZED ALUMINIUM
- GC CLEAR GLASS BALUSTRADE WITH STAINLESS STEEL HANDRAIL
 - STAINLESS STEEL HANDRAIL

 (\mathbf{SS})

PS

- PEFORATED METAL NON SCALABLE SCREEN WITH RUST METAL FINISH
- CG COLOURED GLASS DIGITAL IMAGE LANDSCAPE THEME
- CA1 COLOURED ALUMINUM CLADDING SYSTEM "ZINTL" - HVG FACADES - OR SIMILAR EXTERNAL CLADDING MATERIAL COLOUR: PACIFIC BLUE
- CA2 COLOURED ALUMINUM CLADDING SYSTEM "DIBOND" HVG FACADES - OR SIMILAR EXTERNAL CLADDING MATERIAL COLOUR: RUBY RED

ADVERTISED COPY - CITY OF MONASH This copied document is made available for the sole purpose of enabling its consideration and review as part of a planning process under the Planning and Environment Act. The document must not be used for any purpose which may breach copyright.



- PS PEFORATED METAL NON SCALABLE SCREEN WITH RUST METAL FINISH
 - TOUGHENED GLASS PANEL WITH PHOTOGRAPHIC IMAGE FIXED TO EXTERNAL FACE OF CONCRETE PANEL



- CA2 COLOURED ALUMINUM CLADDING SYSTEM "DIBOND" HVG FACADES - OR SIMILAR EXTERNAL CLADDING MATERIAL COLOUR: RUBY RED
- (AR2) ACRYLIC RENDER FINISH TYPE 2
- COLOUR: SHALE GREY

PETRIDIS ARCHITECTS

LEVEL 1 / 173 UPPER HEIDELBERG ROAD IVANHOE VIC 3079 TEL: 9499 8826 EMAIL: office®petridisarchitects.com.au

PROJECT TITLE


PROPOSED MIXED USE DEVELOPMENT AT 170-174 HIGHBURY ROAD, MOUNT WAVERLEY

SECONDARY CONSENT.2 APPLICATION

DRAWING TITLE


MINOR AMENDMENTS ELEVATIONS

DATE:	SCALE:	
15.07.20	1:100	NORTH
DRAWN:	CHECKED:	
M.S/M.I/S.L	G.P	
JOB No:		
20-08		
DWG No:		REVISION
TP05		N

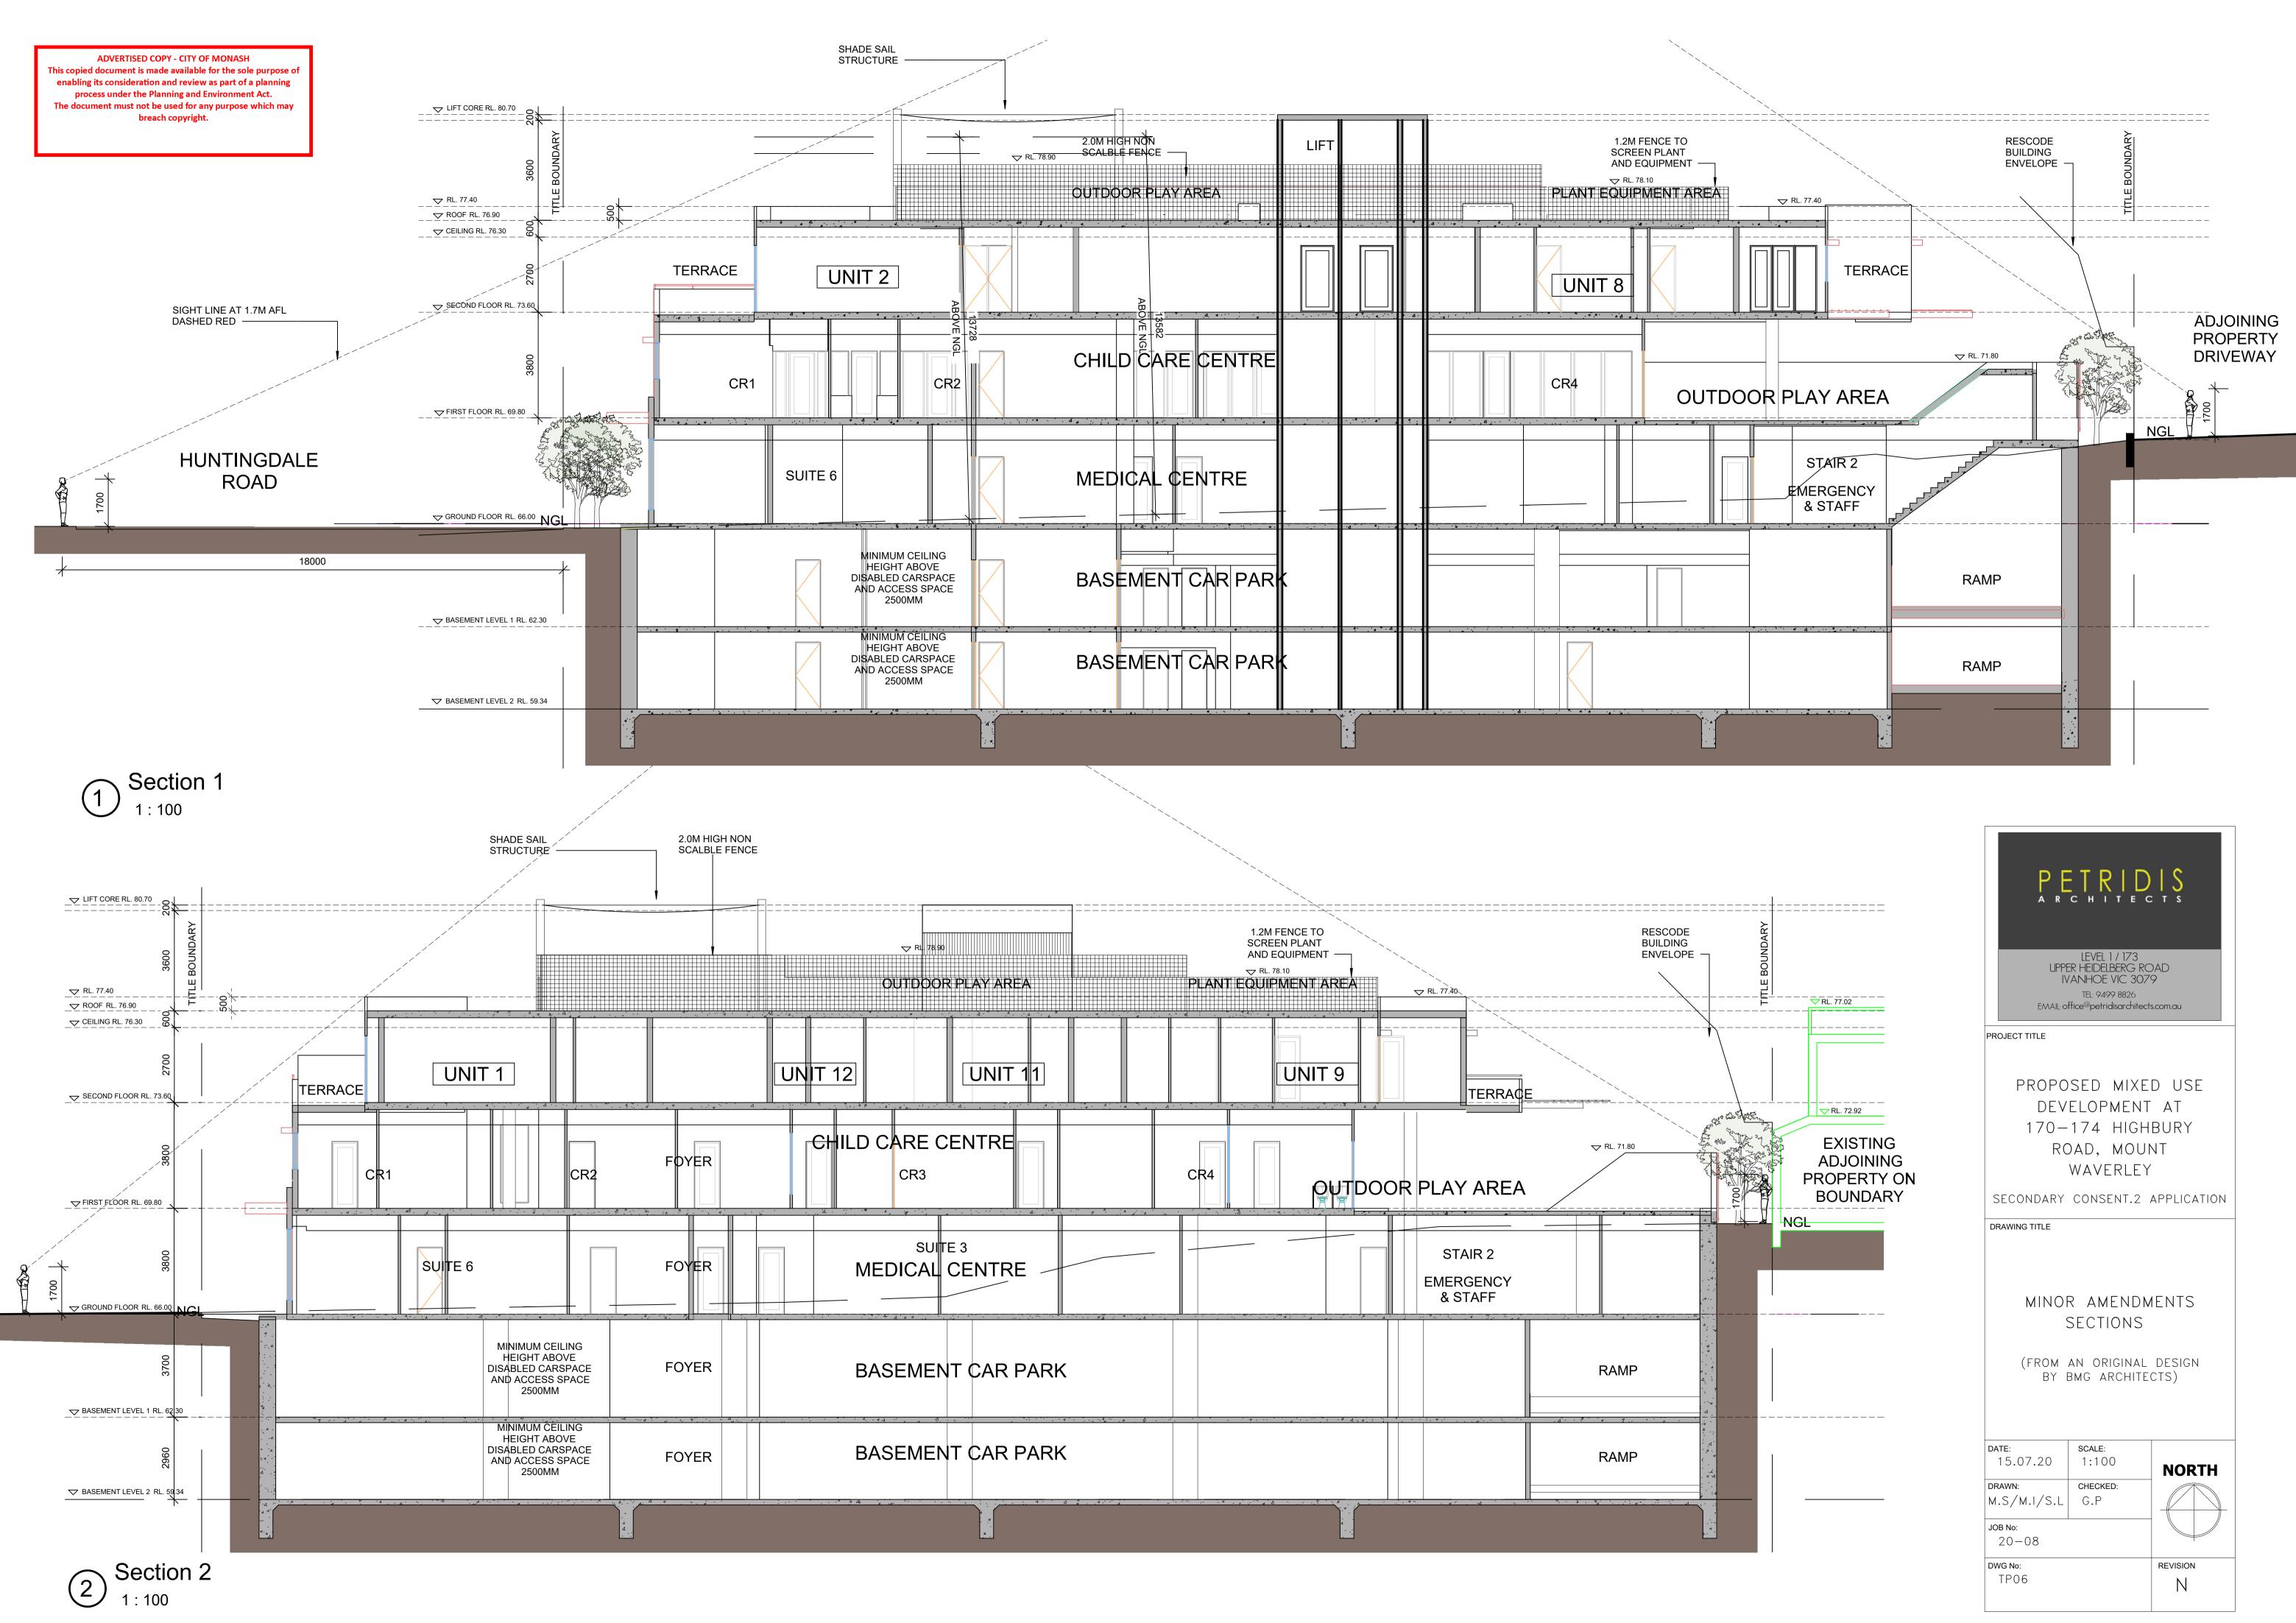

	S
ARCHITE	СТЅ

scale : 1 : 100	NORTH
checked: G.P	
	REVISION
	1:100

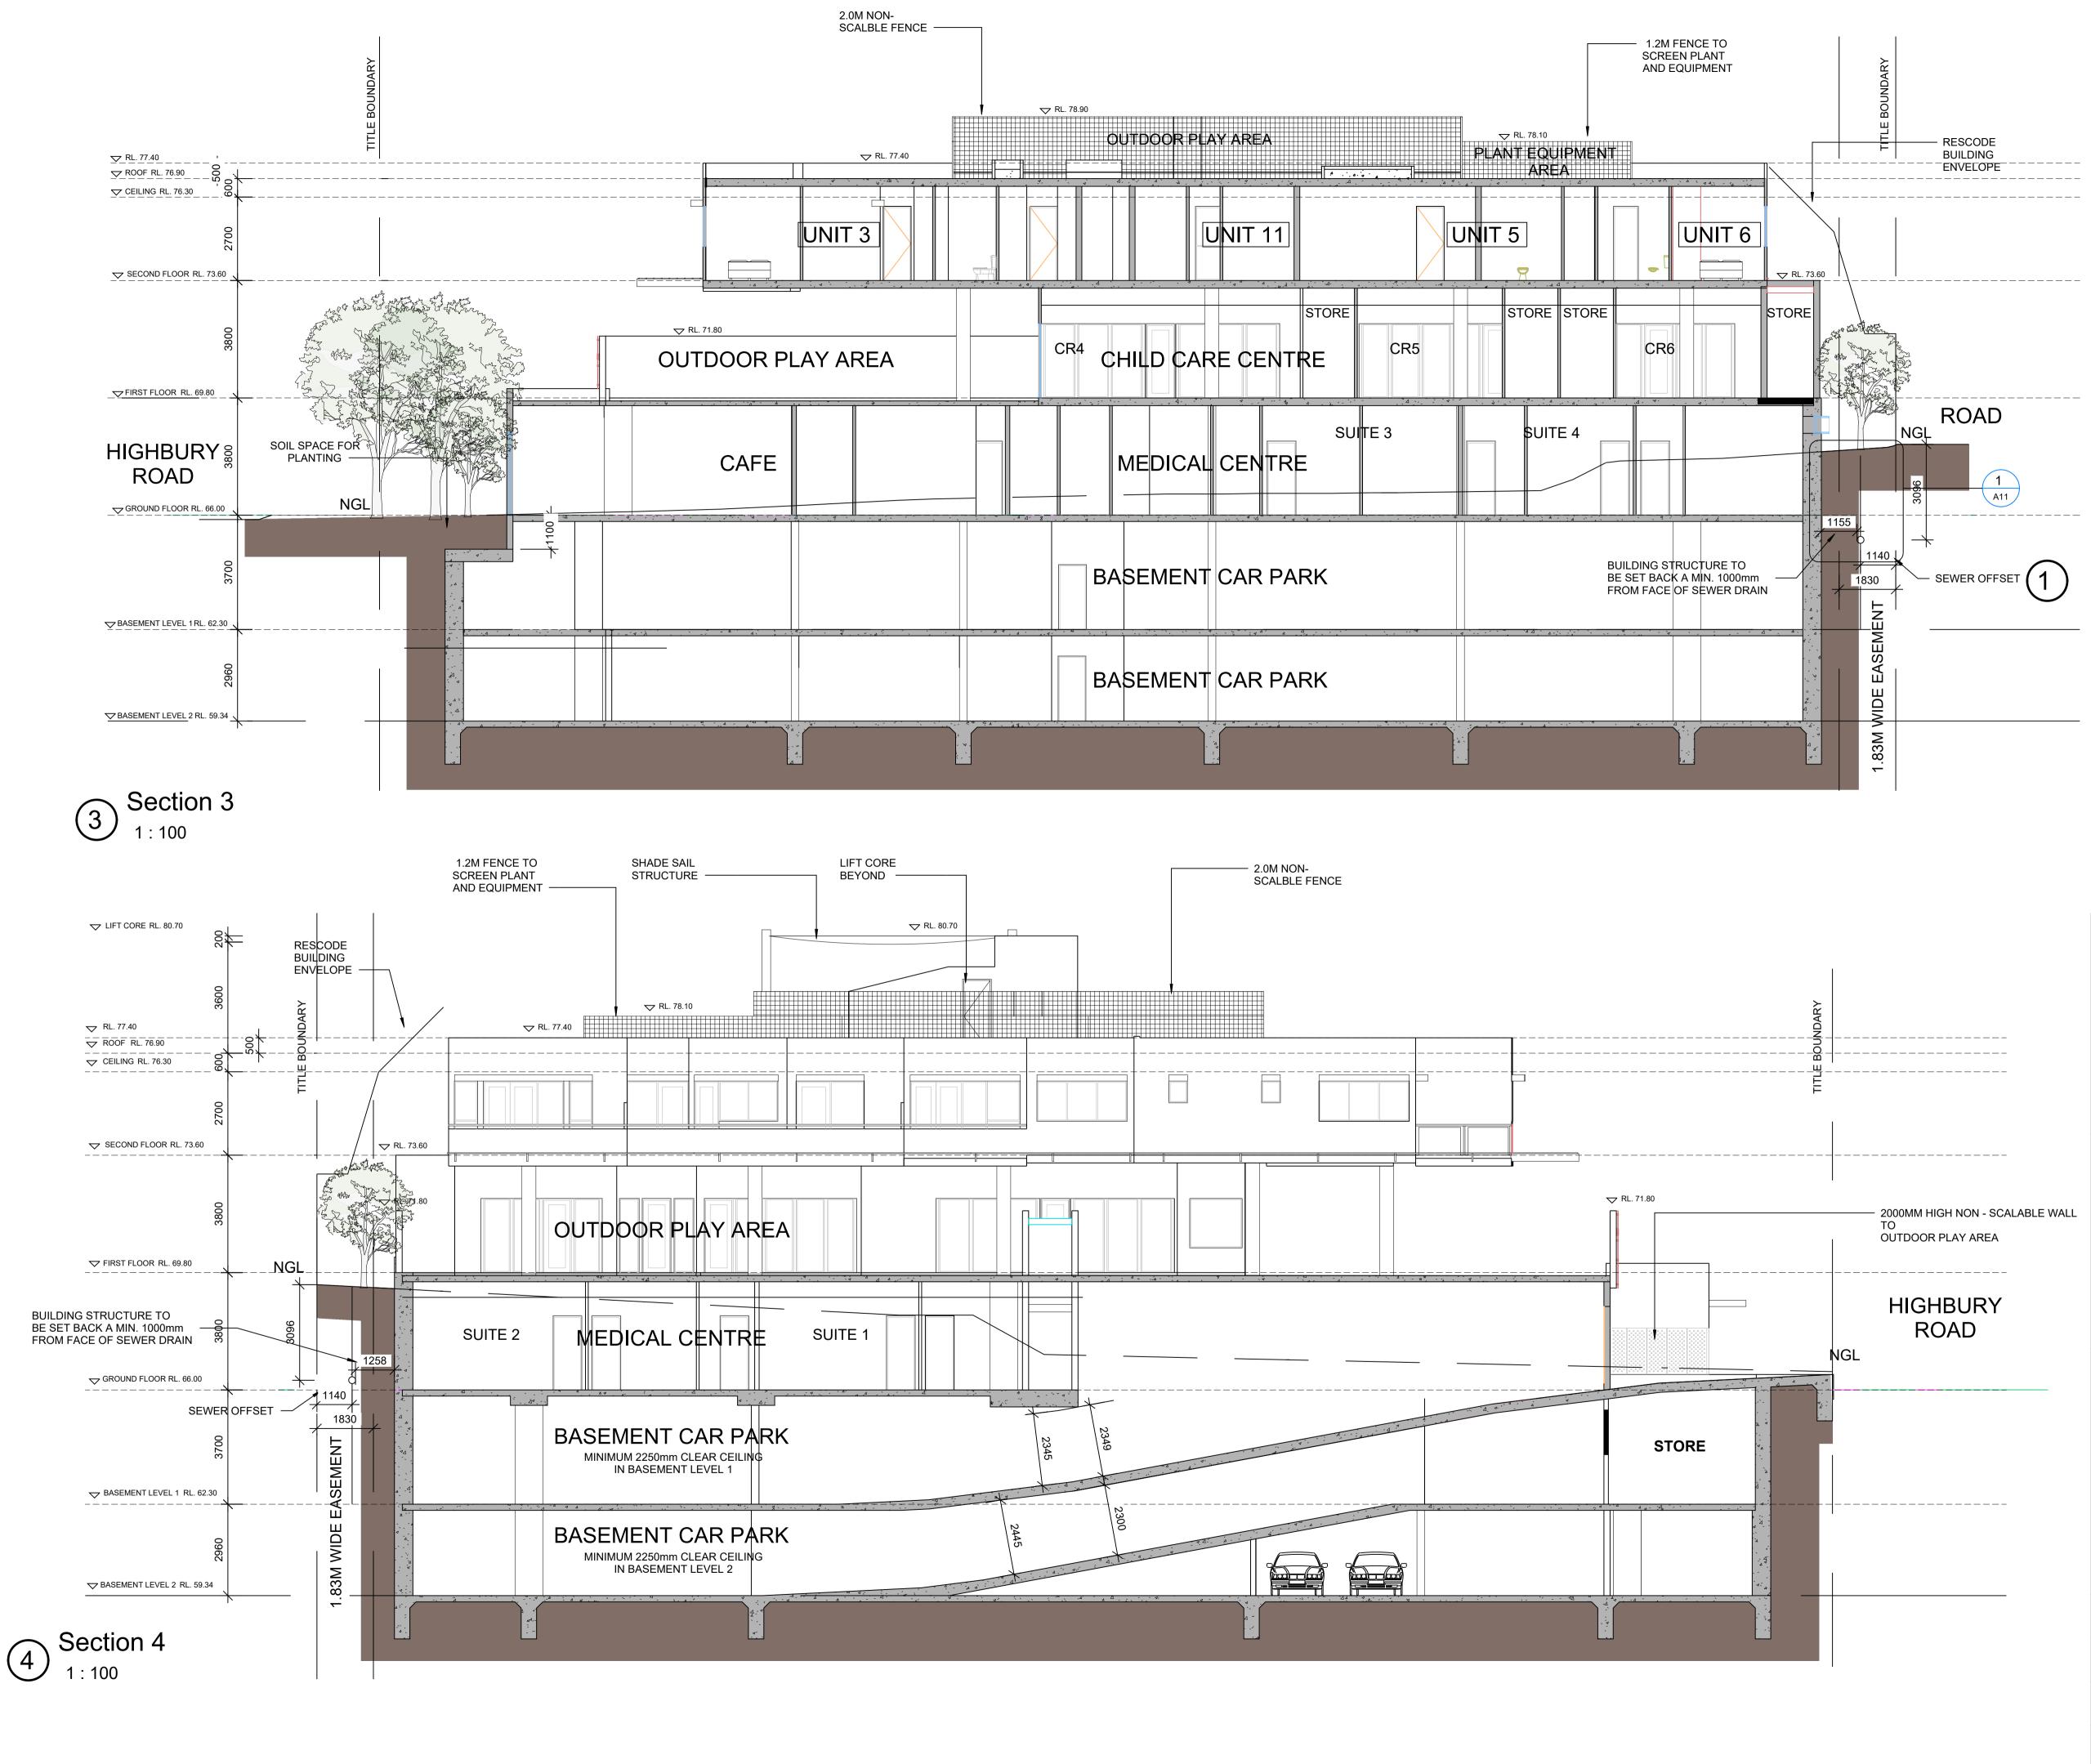

PETRIDIS ARCHITECTS

LEVEL 1 / 173 UPPER HEIDELBERG ROAD IVANHOE VIC 3079 TEL: 9499 8826 EMAIL: office@petridisarchitects.com.au

PROJECT TITLE


PROPOSED MIXED USE DEVELOPMENT AT 170-174 HIGHBURY ROAD, MOUNT WAVERLEY


SECONDARY CONSENT.2 APPLICATION

DRAWING TITLE

MINOR AMENDMENTS SECTIONS

date : 15.07.20	scale : 1 : 100	NORTH
drawn: M.S/M.I/S.L	снескед: G.P	
JOB No: 20-08		
dwg no: TP07		REVISION N

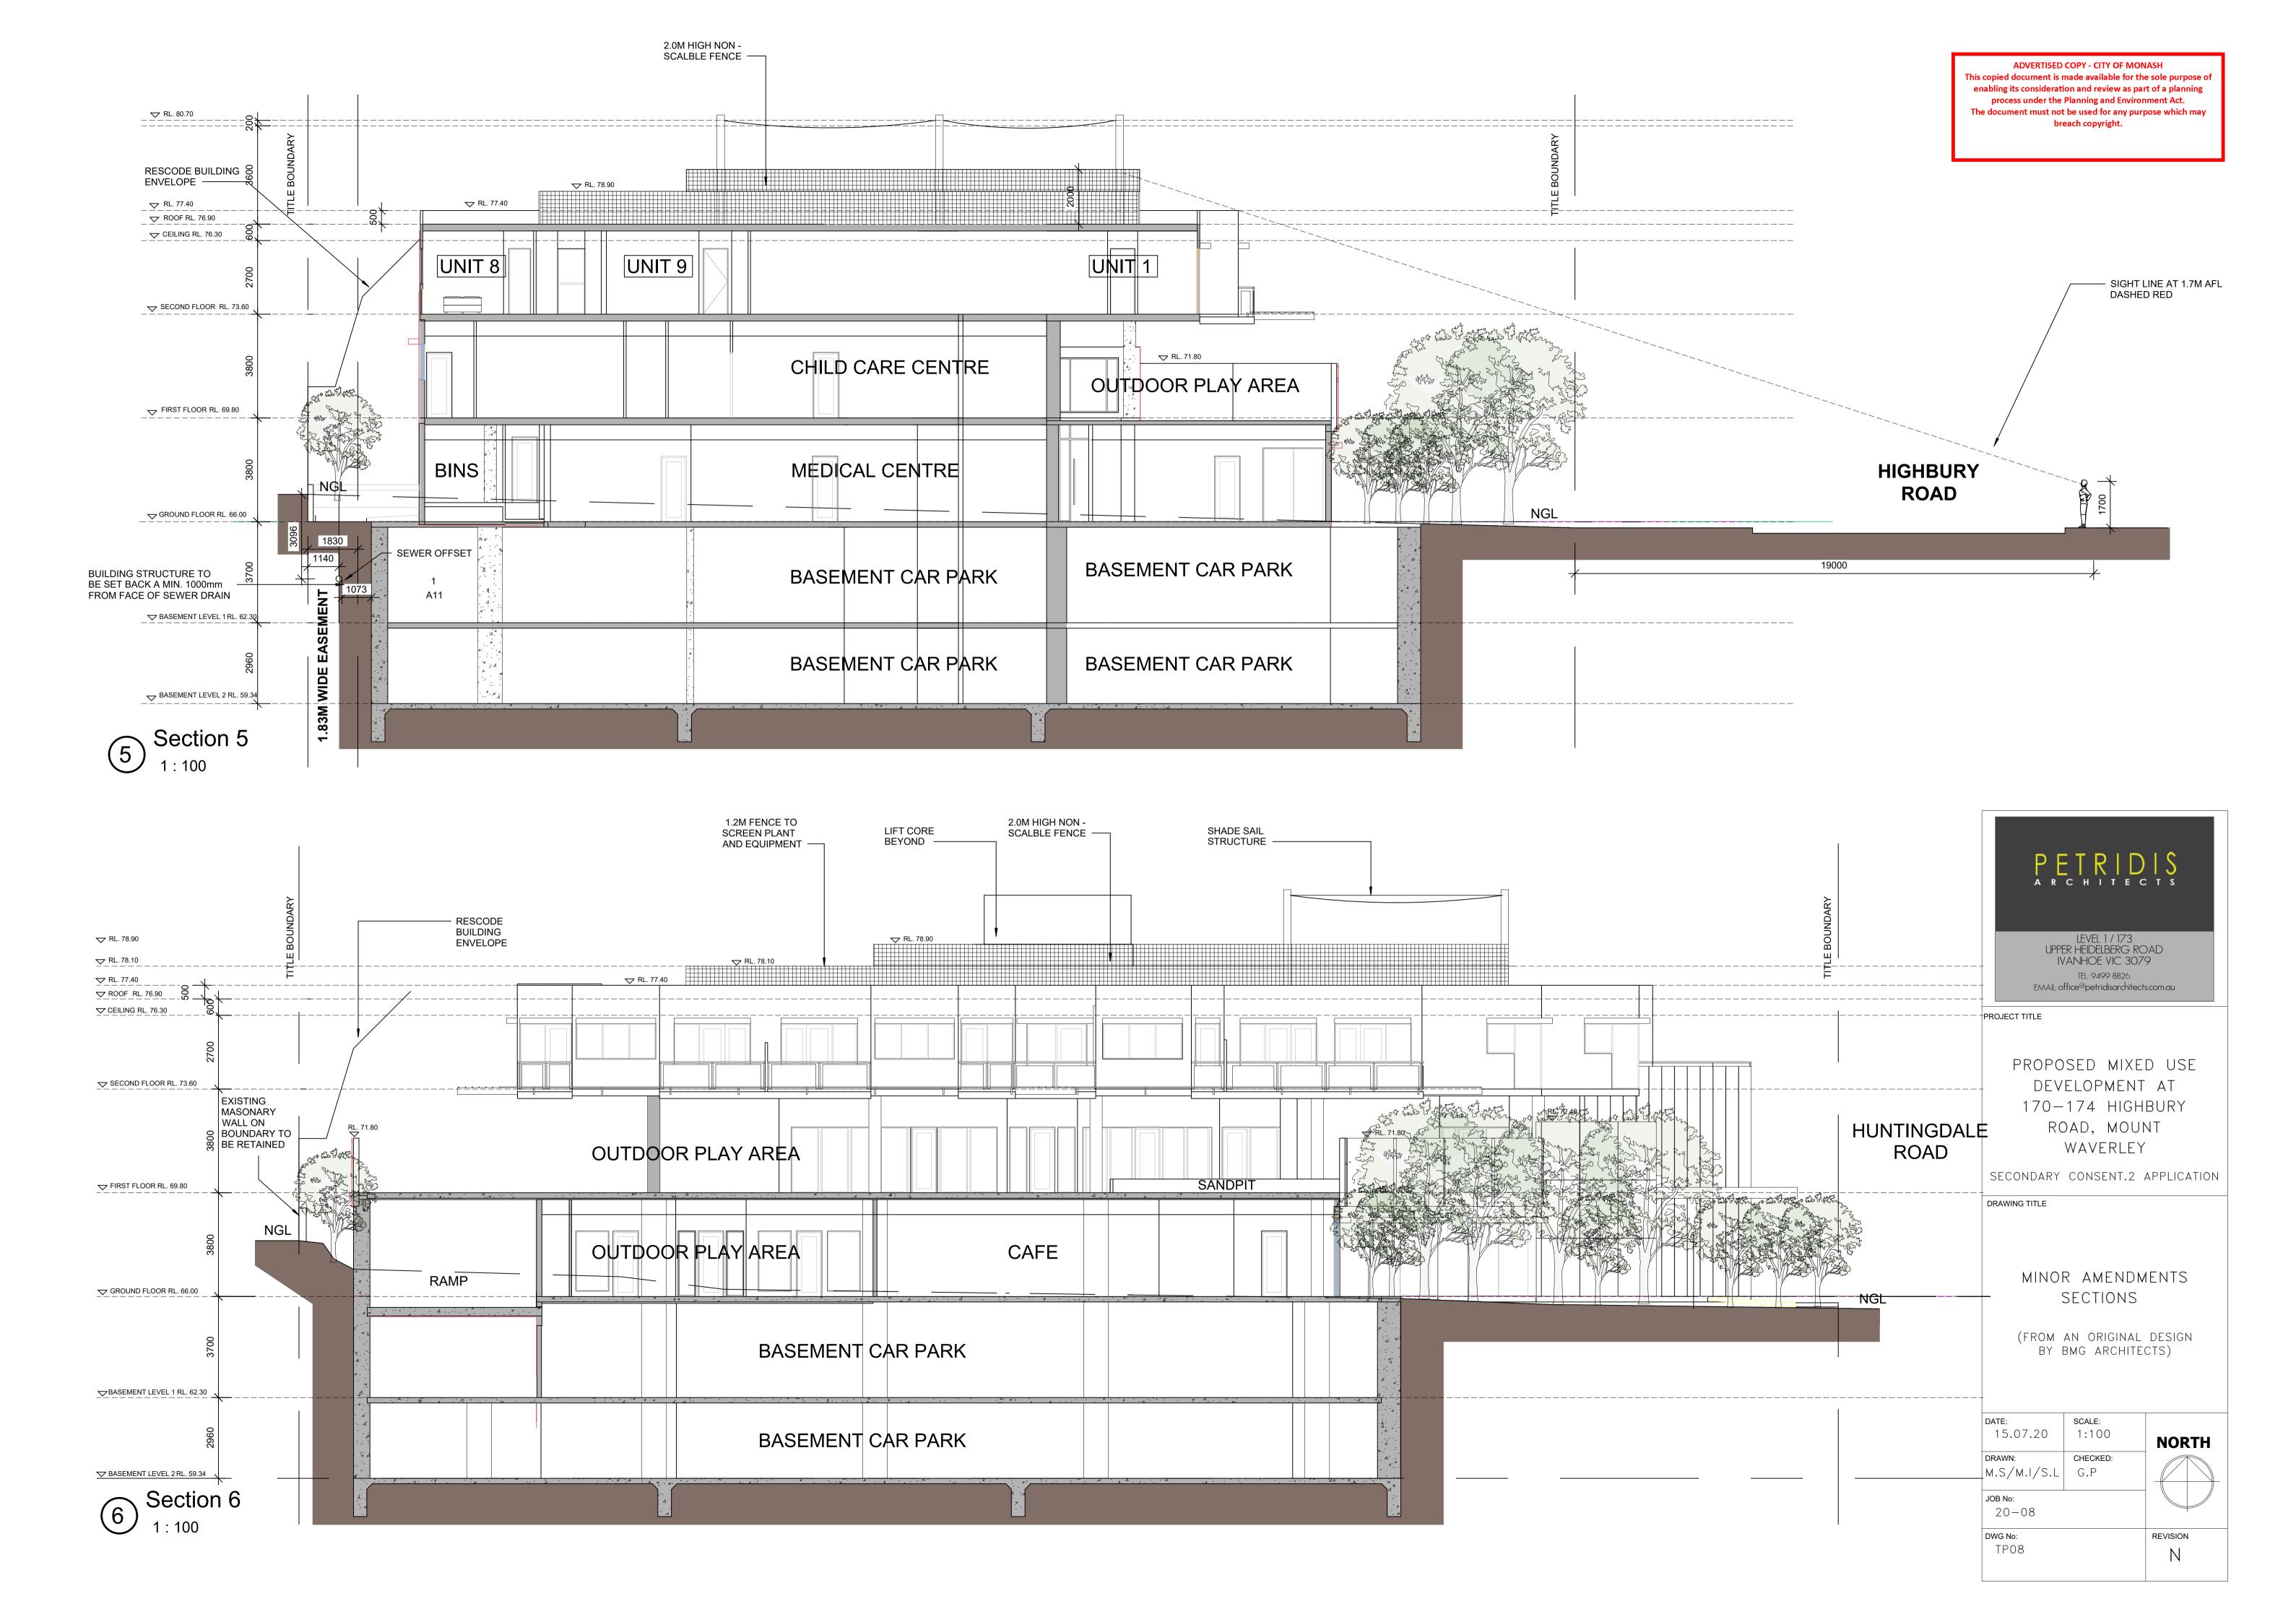

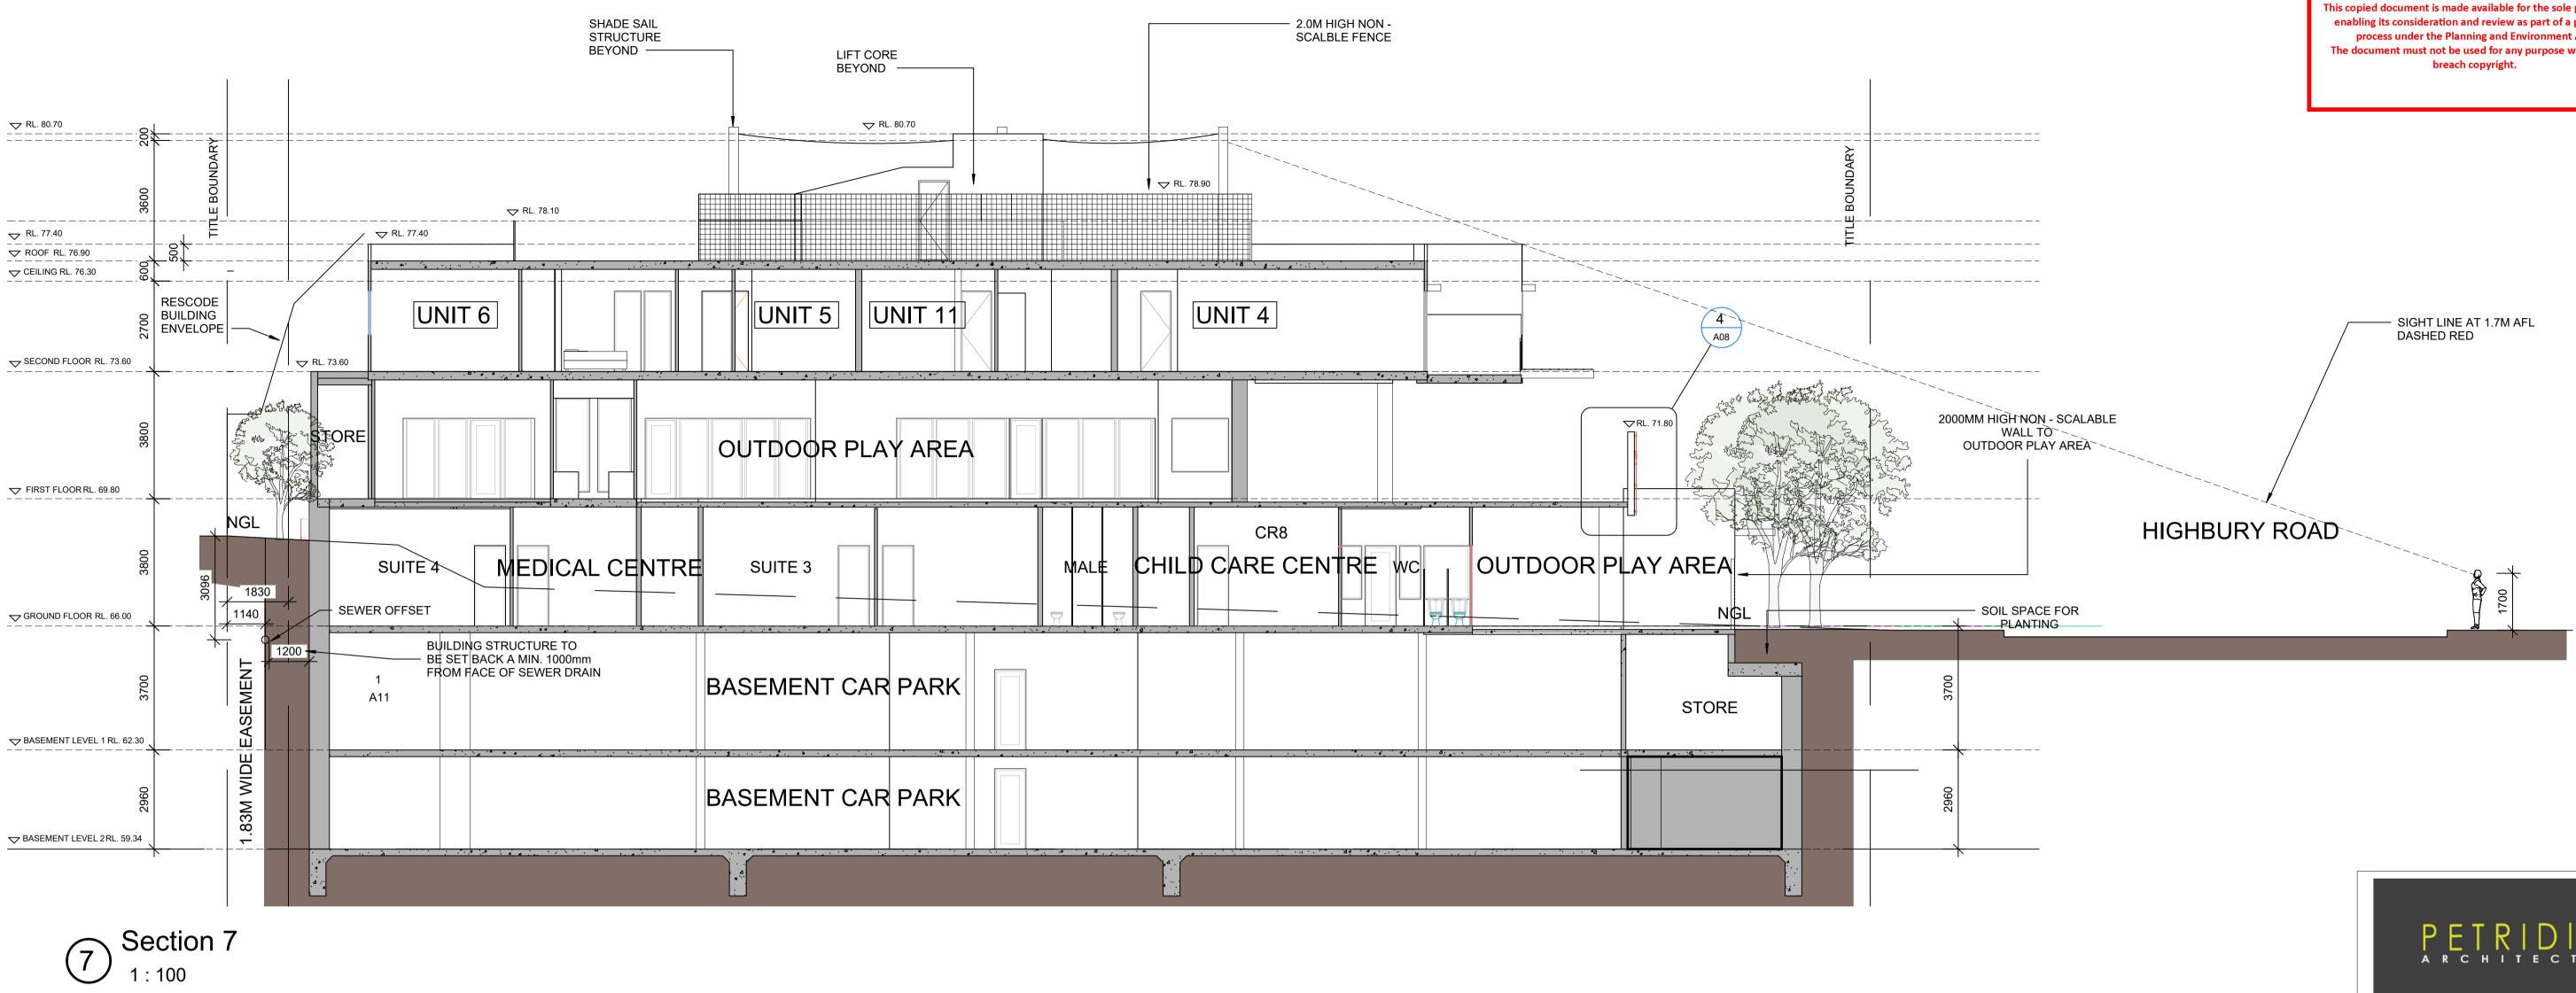



PETRIDIS A R C H I T E C T S			
LEVEL 1 / 173 UPPER HEIDELBERG ROAD IVANHOE VIC 3079 TEL: 9499 8826 EMAIL: office®petridisarchitects.com.au			
PROJECT TITLE			
PROPOSED MIXED USE DEVELOPMENT AT 170—174 HIGHBURY ROAD, MOUNT WAVERLEY			
SECONDARY CONSENT.2 APPLICATION			
DRAWING TITLE			
MINOR AMENDMENTS SECTIONS (FROM AN ORIGINAL DESIGN BY BMG ARCHITECTS)			
DATE: SCALE: 15.07.20 1:100	NODTU		
DRAWN: CHECKED: M.S/M.I/S.L G.P JOB No: 20-08	NORTH		
DWG No: TP09	REVISION		